
A-000	Cover Sheet	03/24/2023
C1	Existing Civil Plan	01/16/2023
L1	Landscape Plan	03/24/2023
L2	Streetscape	03/24/2023
L3	Roof Deck Plant Materials	03/24/2023
L4	Roof Deck Materials	03/24/2023
L5	Green Score Calculation	03/24/2023
L6	Green Score - Site Details	03/24/2023
L7	Green Score - Site Details	03/24/2023
L8	Green score - Site Details	03/24/2023
L9	Tree Protection Plan	03/24/2023
L0	Landscape Plan	03/24/2023
LR0	Roof Deck Plan	03/24/2023
L10	Landscape Comments	03/24/2023
A-010	Diagrammatic Section & Bldg Metrics	03/24/2023
A-020	Site Plan	03/24/2023
A-023	Gross Floor Area	03/24/2023
A-024	Leasable Floor Area	03/24/2023
A-100	Basement Floor Plan	03/24/2023
A-101	1st Floor Plan	03/24/2023
A-102	2nd - 4th Floor Plans	03/24/2023
A-103	Roof Plan	03/24/2023
A-301	Primary Front Elevation - Broadway	03/24/2023
A-302	Secondary Front Elevation-Thurston	03/24/2023
A-303	Side Elevations	03/24/2023
AV-1	Perspective at Broadway & Thurston	03/24/2023
AV-2	Perspective at Broadway	03/24/2023
AV-3	Thurston Street Perspective	03/24/2023
AV-4	Proposed Rendering	03/24/2023
AV-5	Proposed Rendering	03/24/2023
AV-6	Proposed Aerial	03/24/2023
AV-7	Proposed Aerial	03/24/2023
AV-8	Shadow Study - Vernal Equinox	03/24/2023
AV-9	Shadow Study - Summer Solstice	03/24/2023
AV-10	Shadow Studies -Summer Solstice /Autumnal Equinox	03/24/2023
AV-11	Shadow Studies -Winter Solstice /Autumnal Equinox	03/24/2023
AV-12	Winter Solstice Shadow Study	03/24/2023



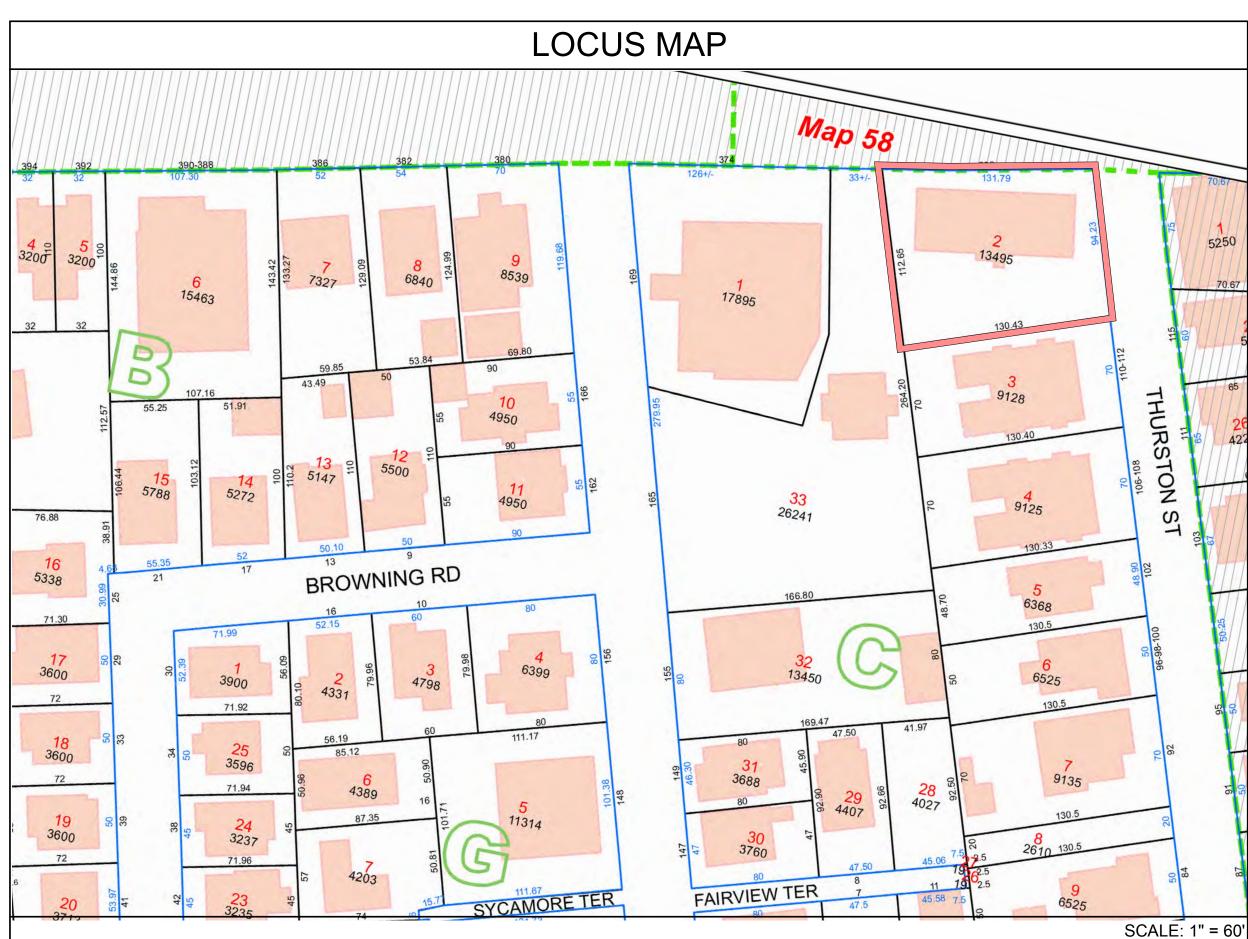

# PROJECT: 366 BROADWAY RESIDENCES

PROJECT ADDRESS:
366 BROADWAY SOMERVILLE, MASSACHUSETTS

ARCHITECT
KHALSA DESIGN INC.
ADDRESS:
17 IVALOO STREET, SUITE 400
SOMERVILLE, MA 02143

LANDSCAPE ARCHITECT
KHALSA DESIGN INC.
ADDRESS:
318 HARVARD STREET, SUITE 25
BROOKLINE, MA 02446

CLIENT
366 BROADWAY LLC
c/o EDWARD DOHERTY
200 BROADWAY, SUITE 103
LYNNFIELD, MA 01940

CIVIL
DGT ASSOCIATES
ADDRESS
803 SUMMER STREET, 1ST FLOOR
BOSTON, MA 02127

DEVELOPMENT REVIEW SET: 03/24/2023

PROJECT NAME

366 Broadway
Residences

PROJECT ADDRESS
366 Broadway
Somerville, MA




KHALSA

17 IVALOO STREET SUITE 400 SOMERVILLE, MA 02143 TELEPHONE: 617-591-8682

CONSULTANTS:

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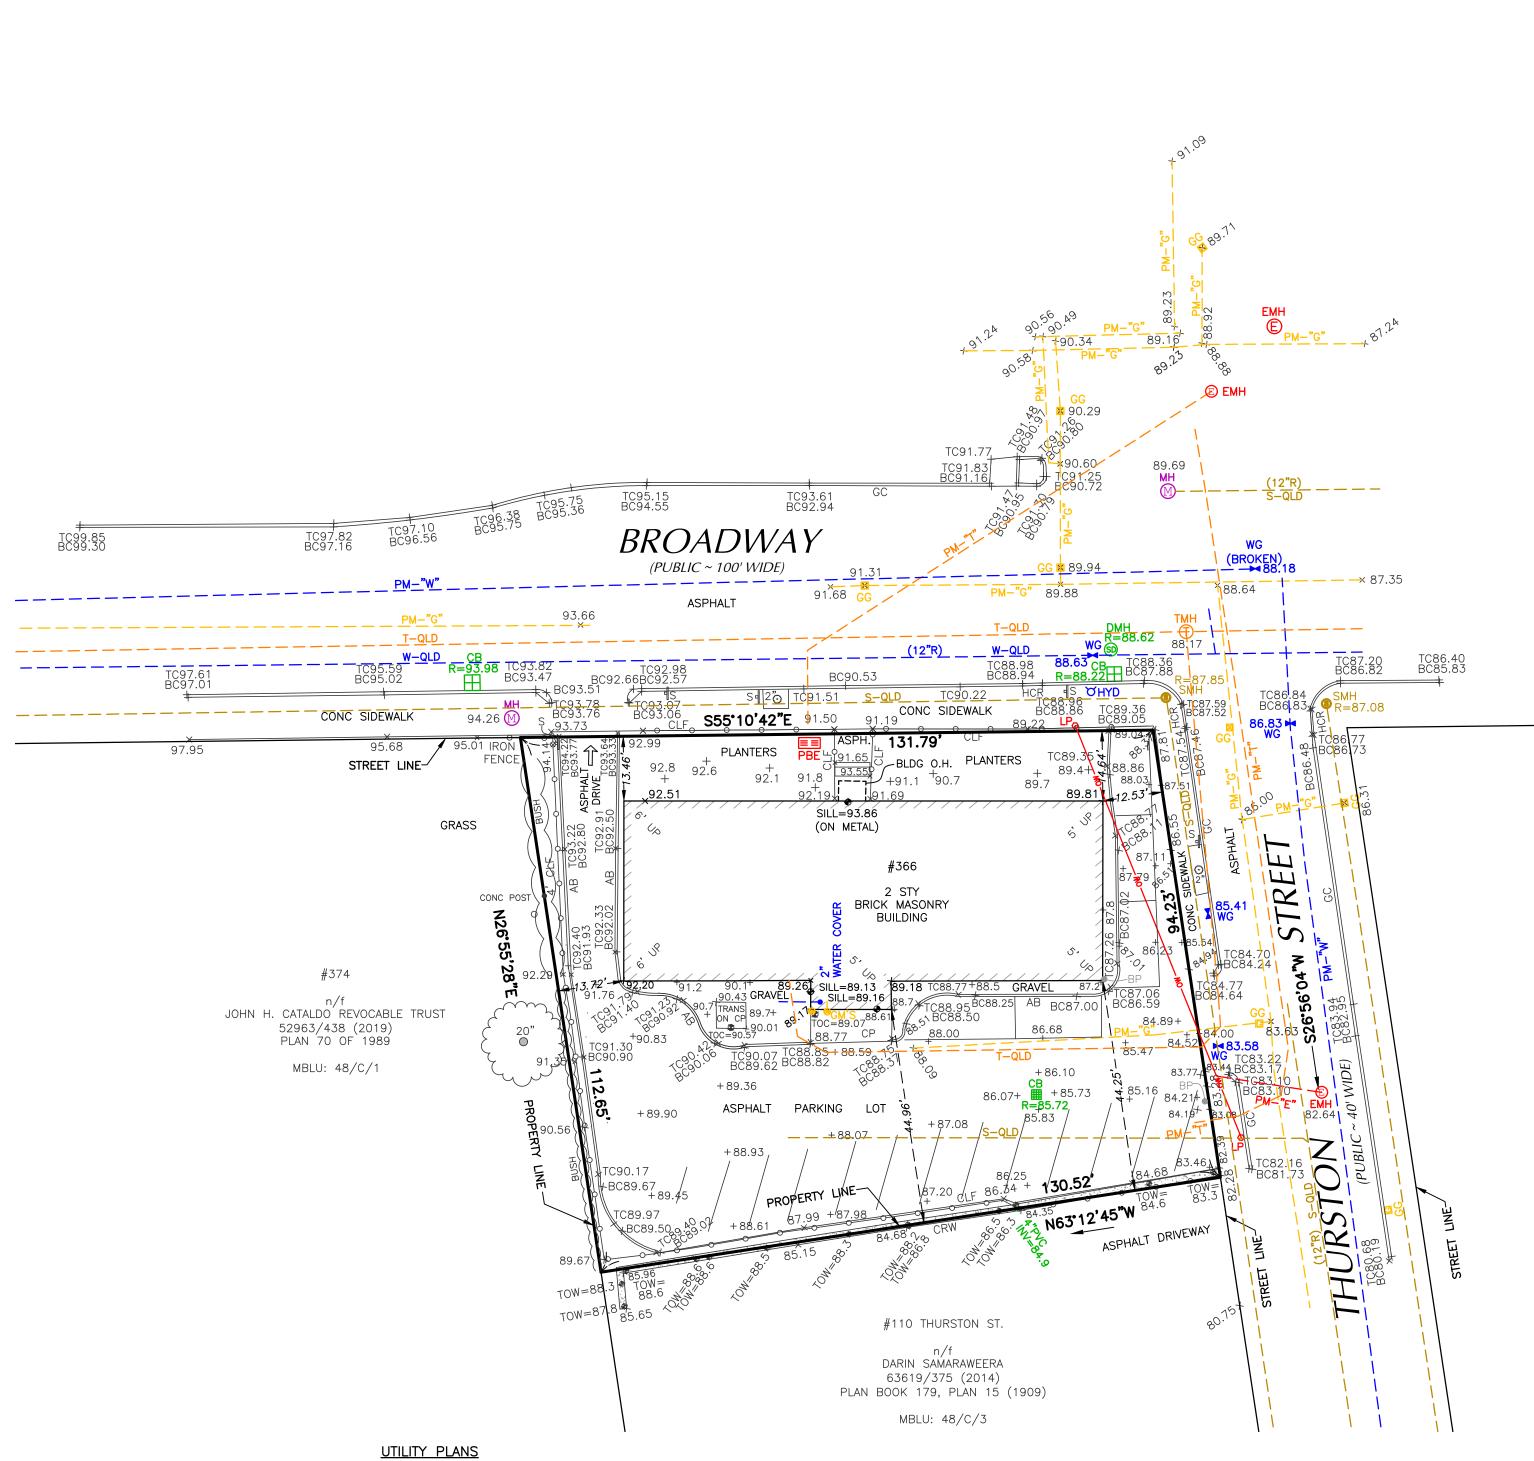
1	Project	number		21071
-1	Date_		03	3/24/2023
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-1	Checke	d by		JSK
-1	Scale		1	" = 60'-0"
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-1	No.	Description		Date
-1				
-1				
-1				
-1				

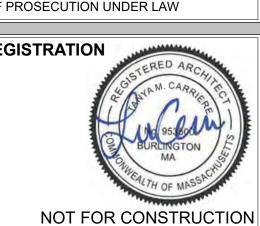Cover Sheet

A-000

366 Broadway Residences

28/2023 9:45:12 AN



VERIZON-SOM26

CITY OF SOMERVILLE ENGINEERING DEPARTMENT

SECTION NO. 5 "WATER WORKS SYSTEM" DATED OCTOBER 1937 BROADWAY SEWER "M-01" DATED JULY 23, 1890 THURSTON STREET SEWER "J-13" DATED AUGUST 18, 1886

## UTILITY NOTES

THE PRINCIPAL GUIDELINES FOR UNDERGROUND UTILITY MAPPING ARE THE AMERICAN SOCIETY OF CIVIL ENGINEERS (ASCE) CI/ASCE 38-02, STANDARD GUIDELINE FOR THE COLLECTION AND DEPICTION OF EXISTING SUBSURFACE UTILITY DATA, 2003.

## UTILITY QUALITY LEVEL INFORMATION INDEX (ASCE/CI 38-02):


QUALITY LEVEL D: "QLD". UTILITY INFORMATION PLOTTED ON THE DRAWING BASED SOLELY ON RECORD INFORMATION, INDIVIDUAL RECOLLECTIONS OR THE EXISTENCE OF UTILITY SERVICE. IT SHALL BE NOTED THAT ALL INFORMATION SHOWN (OTHER THAN AT TEST HOLE LOCATIONS, SEE "QLA" BELOW), INCLUDE BUT NOT LIMITED TO UTILITY SIZE, CAPACITY, MATERIAL COMPOSITION, CONDITION OR SERVICE STATUS SHALL BE CONSIDERED "QLD" EVEN THOUGH THE UTILITY MAY BE PLOTTED AND LABELED AS "QLC" OR "QLB".

QUALITY LEVEL C: "QLC". UTILITY INFORMATION OBTAINED AS ABOVE FOR QUALITY LEVEL D, PLOTTED TO CORRELATE WITH SURFACE UTILITY FEATURES WHICH HAVE BEEN FIELD VERIFIED, SURVEY LOCATED AND ACCURATELY REDUCED ONTO THE DESIGN/CONSTRUCTION DOCUMENTS. INCLUDED IN THIS CATEGORY ARE UTILITY DEPICTIONS, WHICH IN THE PROFESSIONAL OPINION OF THE SUBSURFACE UTILITY ENGINEER REPRESENT THE MOST PROBABLE APPROXIMATE HORIZONTAL LOCATION, TYPE AND/OR EXISTENCE OF A UTILITY.

QUALITY LEVEL B: "QLB". UTILITY INFORMATION DERIVED BY ESTABLISHING THE SURFACE HORIZONTAL LOCATION OF A UTILITY USING ELECTRONIC METHODS. SAID INFORMATION IS SUBSEQUENTLY FIELD LOCATED AND ACCURATELY REDUCED ONTO THE DESIGN/CONSTRUCTION DOCUMENTS.

QUALITY LEVEL A: "QLA". UTILITY INFORMATION WHICH HAS BEEN VISUALLY VERIFIED, SURVEY LOCATED (BOTH HORIZONTALLY AND VERTICALLY) AND ACCURATELY REDUCED ONTO THE DESIGN/CONSTRUCTION DOCUMENTS. THIS IS TYPICALLY SHOWN AS A TEST HOLE OR OTHER DIMENSIONED INFORMATION.

ALL UNDERGROUND UTILITIES SHOWN HEREON ARE QUALITY LEVEL "D" (QLD) PER ASCE STANDARD 38-02 DESIGNATION UNLESS OTHERWISE NOTED. THEY ARE APPROXIMATE ONLY AND WERE COMPILED ACCORDING TO AVAILABLE RECORDS FROM THE VARIOUS COMPANIES AND PUBLIC AGENCIES. ACTUAL LOCATIONS MUST BE DETERMINED IN THE FIELD. BEFORE DESIGNING, EXCAVATING, BLASTING, INSTALLING, BACKFILLING, GRADING, PAVEMENT RESTORATION, REPAVING OR OTHER CONSTRUCTION, ALL UTILITY COMPANIES MUST BE NOTIFIED INCLUDING THOSE IN CONTROL OF UTILITIES NOT SHOWN ON THIS PLAN. SEE CHAPTER 370, ACTS OF 1963, MASSACHUSETTS. CALL "DIG-SAFE" AT 1-888-344-7233 OR DIAL 811. DGT SURVEY GROUP ASSUMES NO RESPONSIBILITY FOR DAMAGES INCURRED AS A RESULT OF UTILITIES OMITTED OR INACCURATELY SHOWN. BEFORE FUTURE CONNECTIONS, THE APPROPRIATE UTILITY ENGINEERING DEPARTMENTS MUST BE CONSULTED.

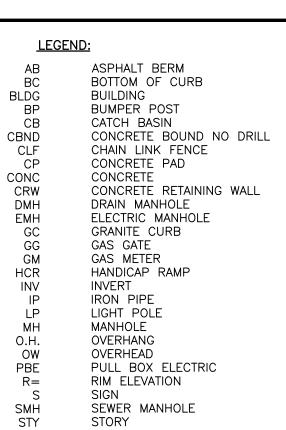

STORY
TOP OF CURB
TELEPHONE MANHOLE
TOP OF CONCRETE
TOP OF WALL
TRANSFORMER
WATER GATE

FOUND


TMH TOC

TRANS

TREE-DIAMETER AT BREAST HEIGHT

PAINT MARK FOUND ELECTRIC

PAIN MARK FOUND GAS
PAIN MARK FOUND TELEPHONE
PAIN MARK FOUND WATER

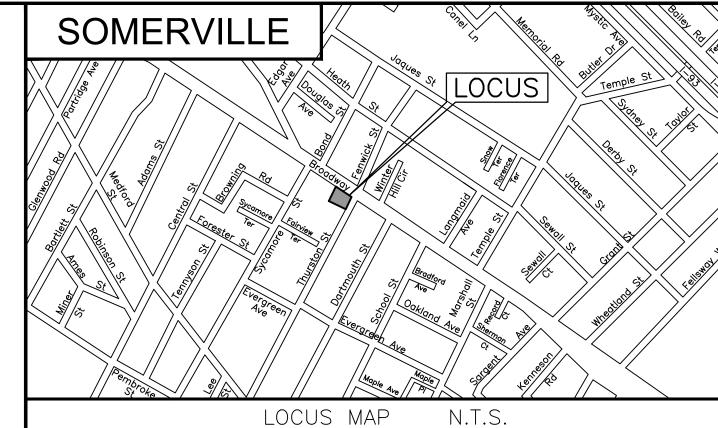

<u>REFERENCE</u>

OWNER OF RECORD: n/f 366 BROADWAY LLC 72441/78 (2019) PLAN BOOK 179, PLAN 15 (1909) AREA = 13,502 SQ. FT.

ASSESSOR MBLU: 48/C/2

## PLAN REFERENCES

CITY NOTE BOOK 2, PAGES 6-8 """31, "188-195 ""40, "78-79

MIDDLESEX COUNTY REGISTRY OF DEEDS

PLAN 549 OF 2005 " 70 OF 1989

## NOTES

1) FIELD SURVEY PERFORMED: SEPTEMBER 17, 24, 2021 AND NOVEMBER 17, 2022.

2) ELEVATIONS SHOWN REFER TO THE NORTH AMERICAN VERTICAL DATUM OF 1988 (NAVD 88) AS ESTABLISHED BY GPS OBSERVATIONS.

## I HEREBY CERTIFY THAT:

THIS PLAN IS BASED ON AN ON-THE-GROUND SURVEY AND PRESENTS THE FACTS AS FOUND AT THE TIME OF THE SURVEY.



PROFESSIONAL LAND SURVEYOR

16-SAN-2023 DATE

> SCALE: 1" = 20' 0 10 20 40

> > 17-NOV-2022

JOB NO. S-1656.01

CRD FILE

S-1656-ALL\_ NAD83\_NAVD88

SHEET NO.

1 OF 1

**RESEARCH:** D. CLIFFORD 366 BROADWAY FIELD: K. GOMES TOPOGRAPHIC PLAN OF LAND CALCULATION: B.T. DRAFTING: SOMERVILLE, MASSACHUSETTS W.S./V.V. MIDDLESEX COUNTY CHECK: CLIFFORD, PLS PREPARED FOR: KEMS CORPORATION PROJ. MANAGER: B. TALEB PREPARED BY:

Surveying & Engineering

Framingham • Boston • Worcester
803 SUMMER STREET, 1ST FLOOR, BOSTON, MA 02127
617.275.0541 www.DGTassociates.com

BY: DESCRIPTION: DATE: REV: 0
PLAN NO.: S-1656 01TP









Existing Zelkova serrata 'Village Green' (Broadway)



Zelkova serrata 'Village Green' Japanese Zelkova



Tree trench with permeable pavers






Tree guard for protecting street tree plantings





Permeable Unit Pavers, Eco-Priora by Unilock OR approved equal

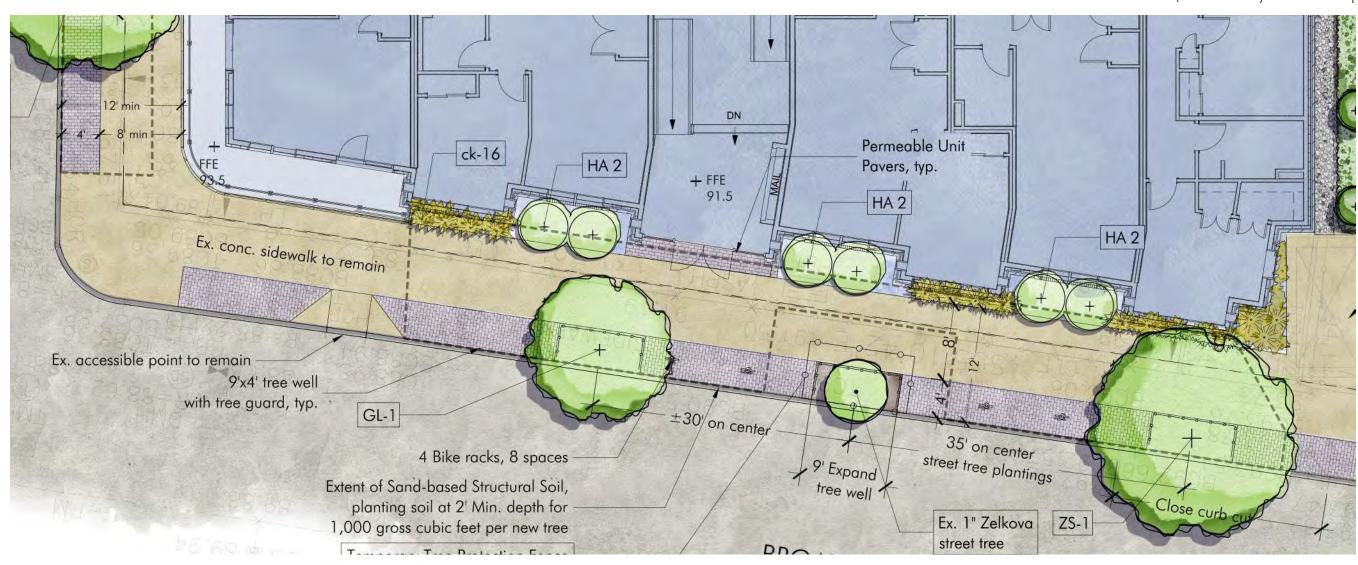




Somerville City-Standard Visitor Bike Rack with City Icon, Hoop by Dero OR approved equal







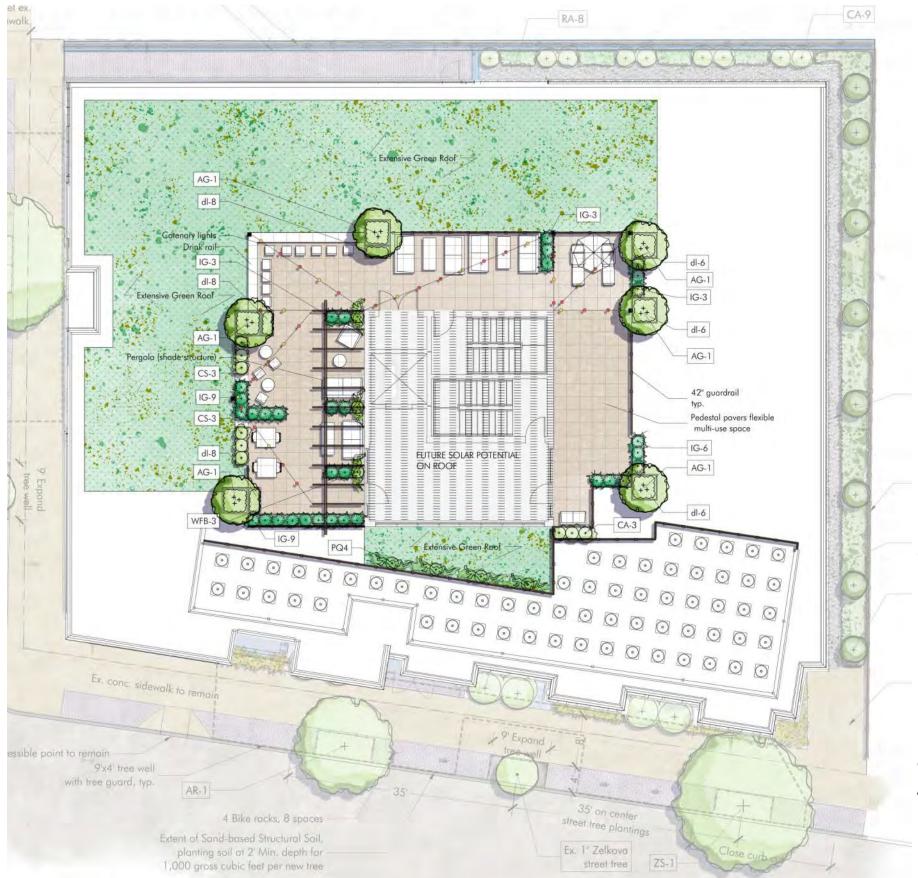

PROPOSED PLANT LIST

SYMB QTY. LATIN NAME COMMON NAME SIZE NOTES

SHRUBS (all  $\geq 2'$  height)

AG Amelanchier x grandiflora 'Autumn Brilliance' Serviceberry 2-2.5" Cal. B&B multi-stem CA 3 Clethra alnifolia 'Hummingbird' Summersweet 5 gal. Pots native CS 6 Cornus sericea 'Arctic Fire' Red Twig Dogwood 3 gal. Pots native IG 30 llex glabra 'Gem Box' Dwarf Inkberry 3 gal. Pots native PQ Parthenocissus quinquefolia Virginia Creeper 3 gal. Pots native American Wisteria-lavender blue 5 gal. WFB 3 Wisteria frutescens 'Blue Moon' Pots

PERENNIALS (all <2' height)

dl 42 Dianthus 'Lionheart'

Pink Lionheart Dianthus

1 qt

Pots native



War of the law of Company of the laboratory of t

llex glabra 'Gem Box' Dwarf Inkberry






Cornus sericea 'Arctic Fire' Red Twig Dogwood



Clethra alnifolia 'Hummingbird' Summersweet

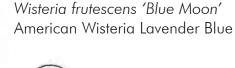









REVISED: MARCH 24, 2023

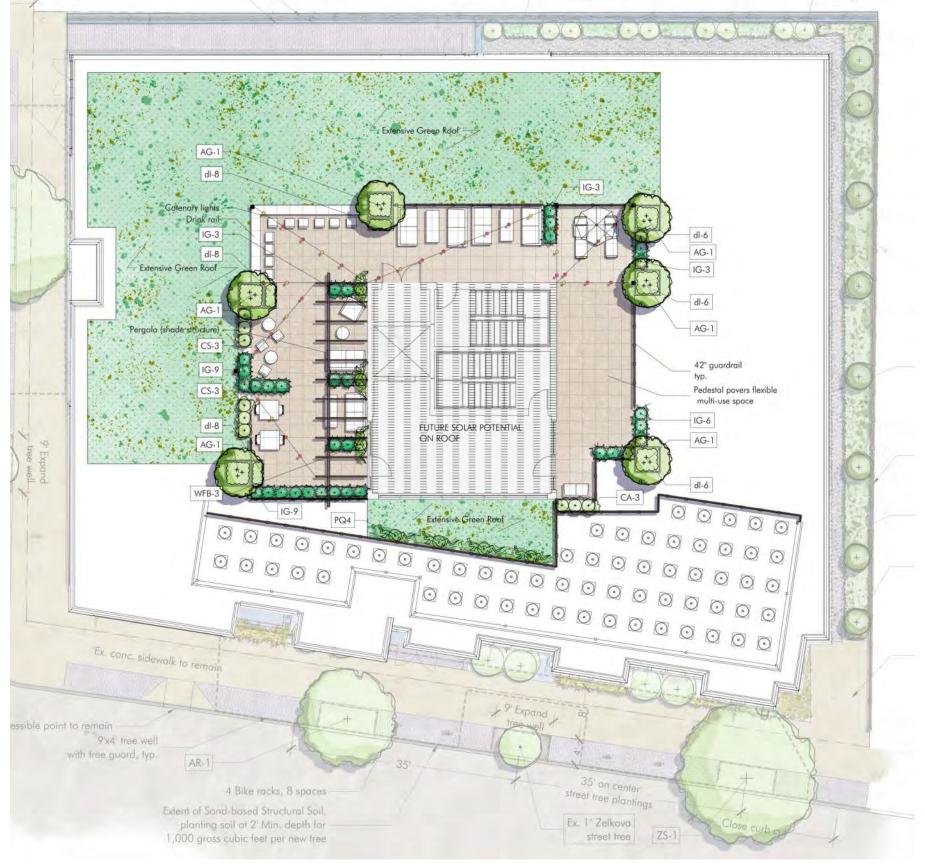





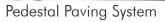





Extensive Greenroof System with Sedum Pergola, shade structure



Catenary Lights









### Somerville Green Score: 366 BROADWAY

Area or Number

13,495

Soils	
Landscaped area with a soil depth less than 24 inches	0
Landscaped area with a soil depth equal to or greater than 24 inches	835
Pervious Paving with 6 to 24 inches of subsurface soil or gravel	295
Pervious Paving with more than 24 inches of subsurface soil or gravel	310
Groundcovers	
Turf grass, mulch, and inorganic surfacing materials	0
Plants	
Vegetation less than two (2) feet tall at maturity	470
Vegetation at least two (2) feet tall at maturity	15
Trees	
Small Tree	0
Large Tree	8
Preserved Tree	0
Engineered Landscape	
Vegetated Wall	
Rain gardens, bioswales, and stormwater planters	
Green Roof with up to 6" of growth medium	
Green Roof with 6"-10" of growth medium	2940
Green Roof of 10"-24" growth medium	
Green Roof of over 24" growth medium	N/A

Sq Ft Credit	Multiplier	Weighted Area	Score Value	% of Score
				1
actual sq ft	0.3	0	0.000	0%
actual sq ft	0.6	501	0.037	12%
actual sq ft	0.2	59	0.004	1%
actual sq ft	0.5	155	0.011	4%
				ı
actual sq ft	0.1	0	0.000	0%
actual sq ft	0.2	94	0.007	2%
12	0.3	54	0.004	1%
				•
50	0.6	0	0.000	0%
450	0.6	2160	0.160	51%
65	0.8	0	0.000	0%
actual sq ft	0.1	0	0.000	0%
actual sq ft	1.0	0	0.000	0%
actual sq ft	0.1	0	0.000	0%
actual sq ft	0.4	1176	0.087	28%
actual sq ft	0.6	0	0.000	0%
Calculate as if soils, groundcovers, plants, and trees				N/A


Green Score =

0.311

Required Score: Target Score: Actual Green Score:

Green Score District Requirements			
NR & UR	MR3 & MR4	MR5, MR6, & HR	FAB, CC, CB, CI
0.35	0.25	0.20	0.20
0.40	0.3	0.25	-
0.311	0.311	0.311	0.311

### KEY PLAN: AT GRADE

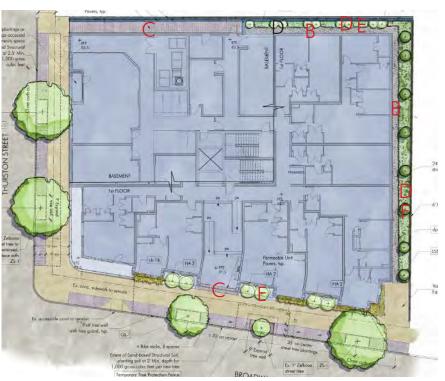


KEY PLAN: ROOF DECK







## TYPICAL PLANT (TREE OR SHRUB) DETAIL

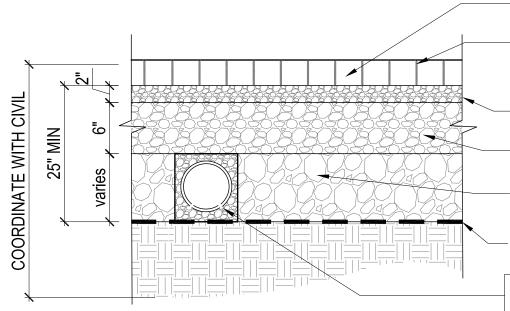

Permeable concrete unit pavers


permeable joint opening aggregate; filled with  $\frac{1}{8}$ " open graded crushed, angular stone; (ASTM #8) 2" Leveling Course open graded FG stone (ASTM #8) Base Course  $\frac{3}{4}$ "-1" open graded stone no fines (ASTM #57) Reservoir Course I  $\frac{1}{2}$ "-3" open graded stone no fines (ASTM #2) Geotextile soil separation, see specification

pvc underdrain pipe; location as shown on Civil drawings, install if infiltration is less than 0.5 in./hr. typ. if shown in Civil drawing


Notes:

- Edge restraints vary see plan.
- All aggregate material shall be crushed, angular stone and free of fines.
- Compact subsoil with a California bearing ratio (cbr) of less than 5% as directed by a professional engineer.
- Surface slope shall be a minimum of 1% and a maximum of 5%.
- Install pvc underdrain pipe where infiltration rate of subsoil is less than 0.5 in./hr. size as directed by a professional engineer.
- Never build permeable pavements on organic clay soils of high plasticity and/or peat, mulch, soils with high organic content.
- Maintain a minimum distance of 2' between bottom of permeable base and water table.
- The minimum aggregate thicknesses are after compaction.



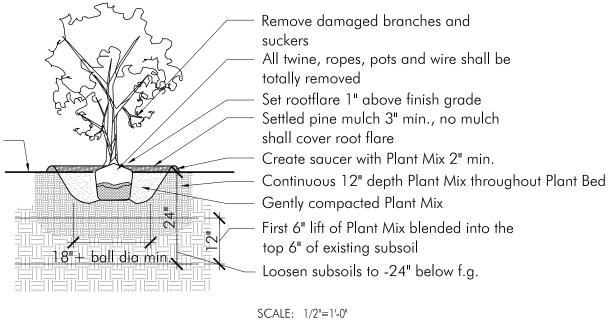

### PERVIOUS CRUSHED STONE MAINTENANCE EDGE

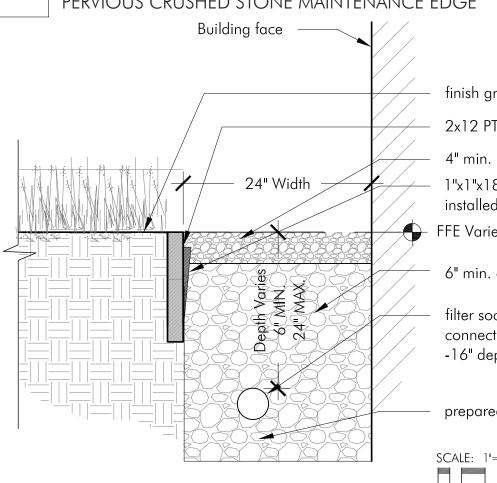

finish grade plant bed

2x12 PT wood edge, staked 24" o.c. and every corner/end

4" min. depth riverstone (1.5-2" rounded riverstone)

1"x1"x18" PT wooden stake with tapered end, installed every 24" o.c.


舟 FFE Varies, See Grading Plan

6" min. depth of  $\frac{3}{4}$ " crushed stone (where no perf. pipe)

filter sock wrapped, 4" perf. pipe at sunken conditions, connect to stormwater system, see civil eng. plans,

-16" depth, extend crushed stone below


prepared free-draining backfill below

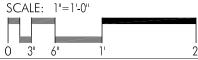






### LIGHTWEIGHT PLANTER

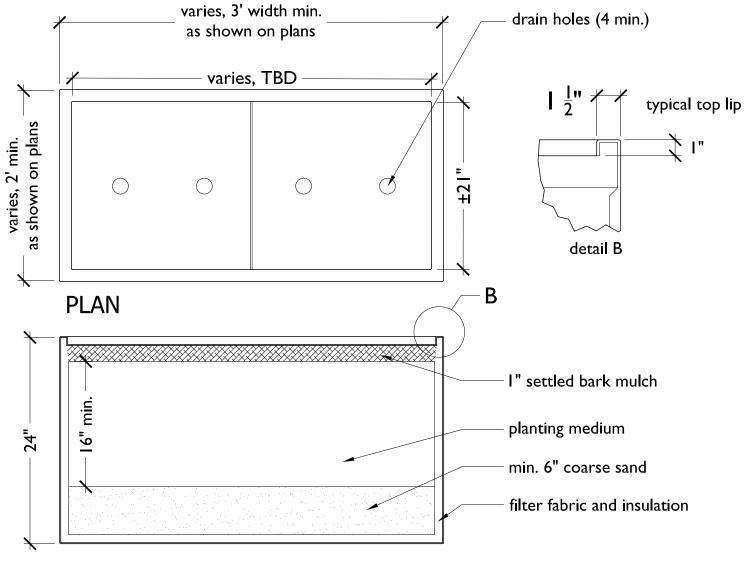


## **SECTION**

### Note:

- Wilshire Planter by Tournesol
- Provide 4 drain holes.
- Provide I" insulation on interior walls and bottom (with drain holes). Align holes for clear drainage.
- Filter fabric shall extend to -2" from top lip.
- Color and texture shall be approved by LA
- See Specification

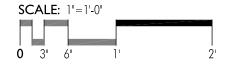

### EXTENSIVE GREEN ROOF DETAIL

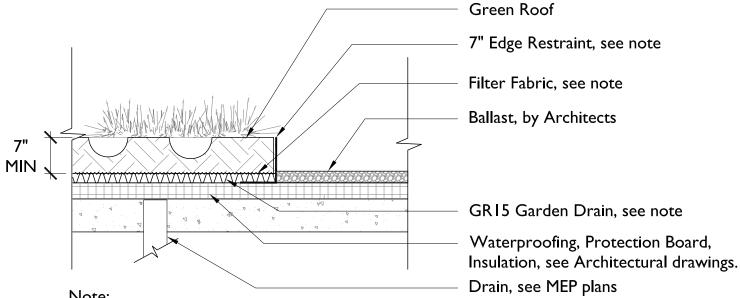


- Note:
- Sedum Sod by Hydrotech or similiar
- Edge Restraint by Permaloc
- Drainage Mat by Hydrotech GR-15 or similiar





### TREE PROTECTION DETAIL


## TYPICAL Existing Tree to be Protected, typ. ALIGN WITH DRIP LINE AND/OR AS SHOWN ON PLAN NOTES: Post spacing a maximum of 6' on center Minimum four posts per tree Adjust location and depth of posts to <u>PLAN</u> avoid tree roots See additional notes below.

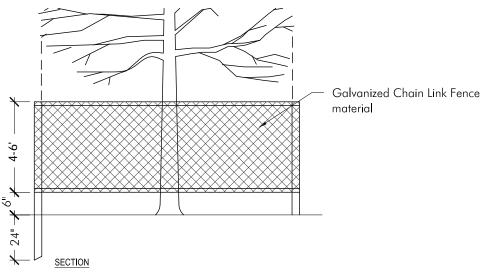

- 1. Installed tree protection must be in place prior to any work (including demolition), and approved by landscape architect. tree protection to remain in place throughout construction, remove for final landscape treatment, after approval by landscape
- 2. Adjust location of tree protection within tree dripline only when necessary to perform work
- 3. Stockpiling of soils, storing of materials, parking of vehicles or location of temporary structures shall not occur at any time within the dripline of trees to remain.
- 4. All work within drip line must be done by

N.T.S

### NEW STREET TREE PLANTING WITH STRUCTURAL SOILS DETAIL

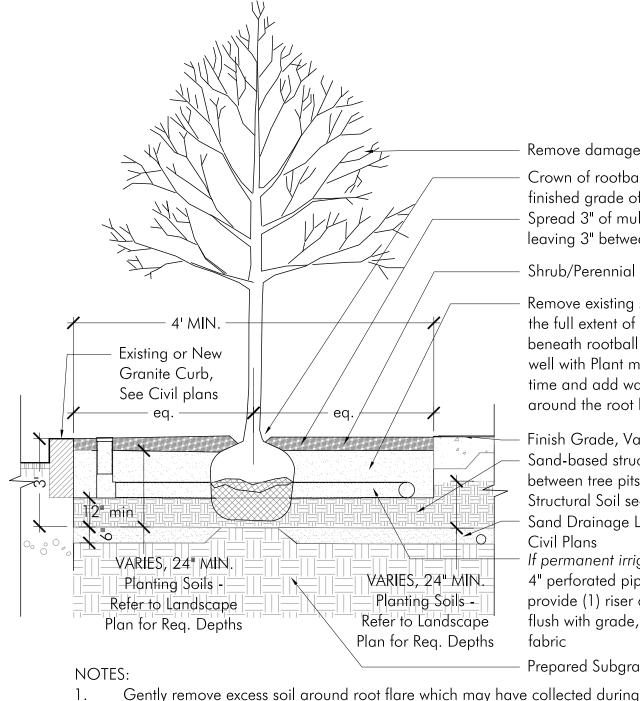

tree spading/B+B operations.

Remove damaged branches and second leader(s)

Crown of rootball shall be 2" higher finished grade of sidewalk

Spread 3" of mulch to fill extent of tree well leaving 3" between mulch and root flare

Shrub/Perennial plantings, see planting plan


Remove existing soil and replace with Plant Mix to the full extent of the tree pit. Firmly compact soil beneath rootball to avoid settlement. Backfill the tree well with Plant mix, in layers not to exceed 6" at one time and add water after every layer of soil is placed around the root ball to thoroughly settle the soil.

Finish Grade, Varies, See Materials & Layout Plan Sand-based structural planting soil, continuous between tree pits, For full extent of required Structural Soil see Materials & Layout Plan Sand Drainage Layer, with drain pipe, Coord. with Civil Plans

If permanent irrigation is not provided: Continuous 4" perforated pipe around perimeter of tree well, provide (1) riser capped with black drain grate set flush with grade, wrap all components with filter fabric

Prepared Subgrade

Provide wooden stakes (3 per tree) and guy wire (rubber hose cover at trunk) in windy locations and as site conditions require, as directed by Landscape Architect.

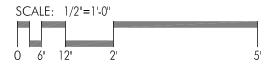







Tree Protection Prior to Site Work:


- 1. Prior to initiating site work, the Contractor shall install a 4' ht. chain link construction fence as shown on the plan to establish the Tree Protection Zone (TPZ). The Contractor shall not enter the tree protection zone with equipment, store equipment or materials within the TPZ for the duration of the construction project. The TPZ shall be maintained throughout the construction period and may only be removed as specifically directed by the Landscape Architect or Town Tree Warden.
- 2. In locations where excavation and construction work will be within the Tree Protection Zone (TPZ), the Contractor shall meet with the Landscape Architect to describe the scope of excavation or filling. Equipment shall not operate within the TPZ except as approved and directed by Landscape Architect. Typically, equipment shall set up and operated from beyond the TPZ. This may involve some adjustment in the location of chain link fencing.
- 3. A certified arborist shall be hired to cut and prune limbs and branches that may hinder construction operations or overhang the proposed building.

- 4. Install 2 to 3 inches of woodchip mulch or a blend of composted woodchips and bark mulch over the entire TPZ or 30' from the tree protection fence-- which ever is less.
- 5. The tree protection fence shall not be removed until the end of the construction of the buildings at such time as the lawn work and plantings work is initiated. The Contractor shall request and get approval to remove the tree protection fence by the Landscape
- 6. The Contractor shall set up and provide a temporary irrigation system in all the TPZ areas as directed by the Landscape Architect or Arborist. During the growing season (June 1 through October 1), the irrigation system shall supply 1" of water after any period of over 1 week when there is no natural rainfall. This added water will support vigorous tree growth allowing the tree to recover from the root damage from construction.


TREE SURVEY			
Species	DBH (inches)	Heath	
Zelkova	]"	Good	To Remain + To Protect
Zelkova	1"	Poor/ Damaged	To Be Removed

\*Existing DBH as measured on-site February 2022


DBH = Diameter at Breast Height = trunk diameter in inches measured  $4\frac{1}{2}$  feet from the ground

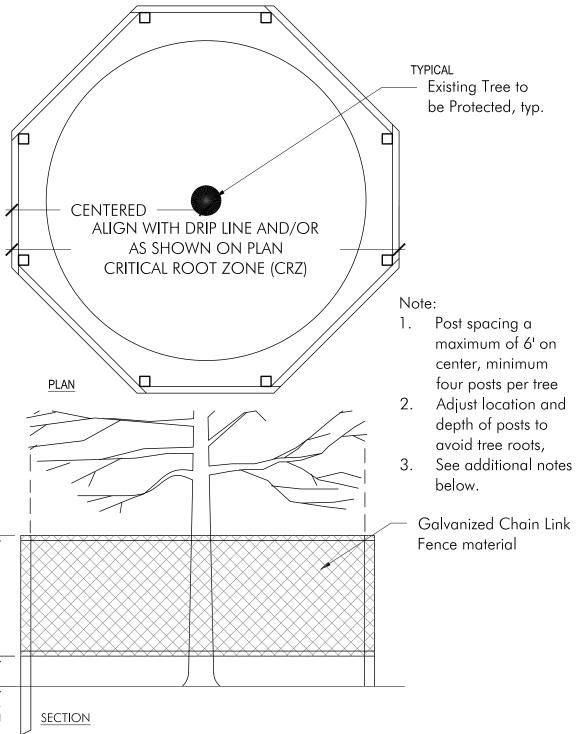

- 1. Installed tree protection must be in place prior to any work (including demolition), and approved by landscape architect. tree protection to remain in place throughout construction. remove for final landscape treatment, after approval by landscape architect.
- 2. Adjust location of tree protection within tree dripline only when necessary to perform work shown on drawings.
- 3. Stockpiling of soils, storing of materials, parking of vehicles or location of temporary structures shall not occur at any time within the dripline of trees to remain.
- 4. All work within drip line must be done by hand.

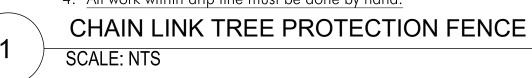



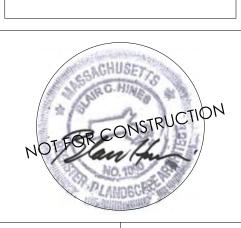

366 BROADWAY SOMERVILLE, MA	TREE PROTECTION PLAN


Project #:	Date: 03/24/2023
Drawn by: JN	Reviewed: BH
Scale: As noted	

	Revisions:

L9

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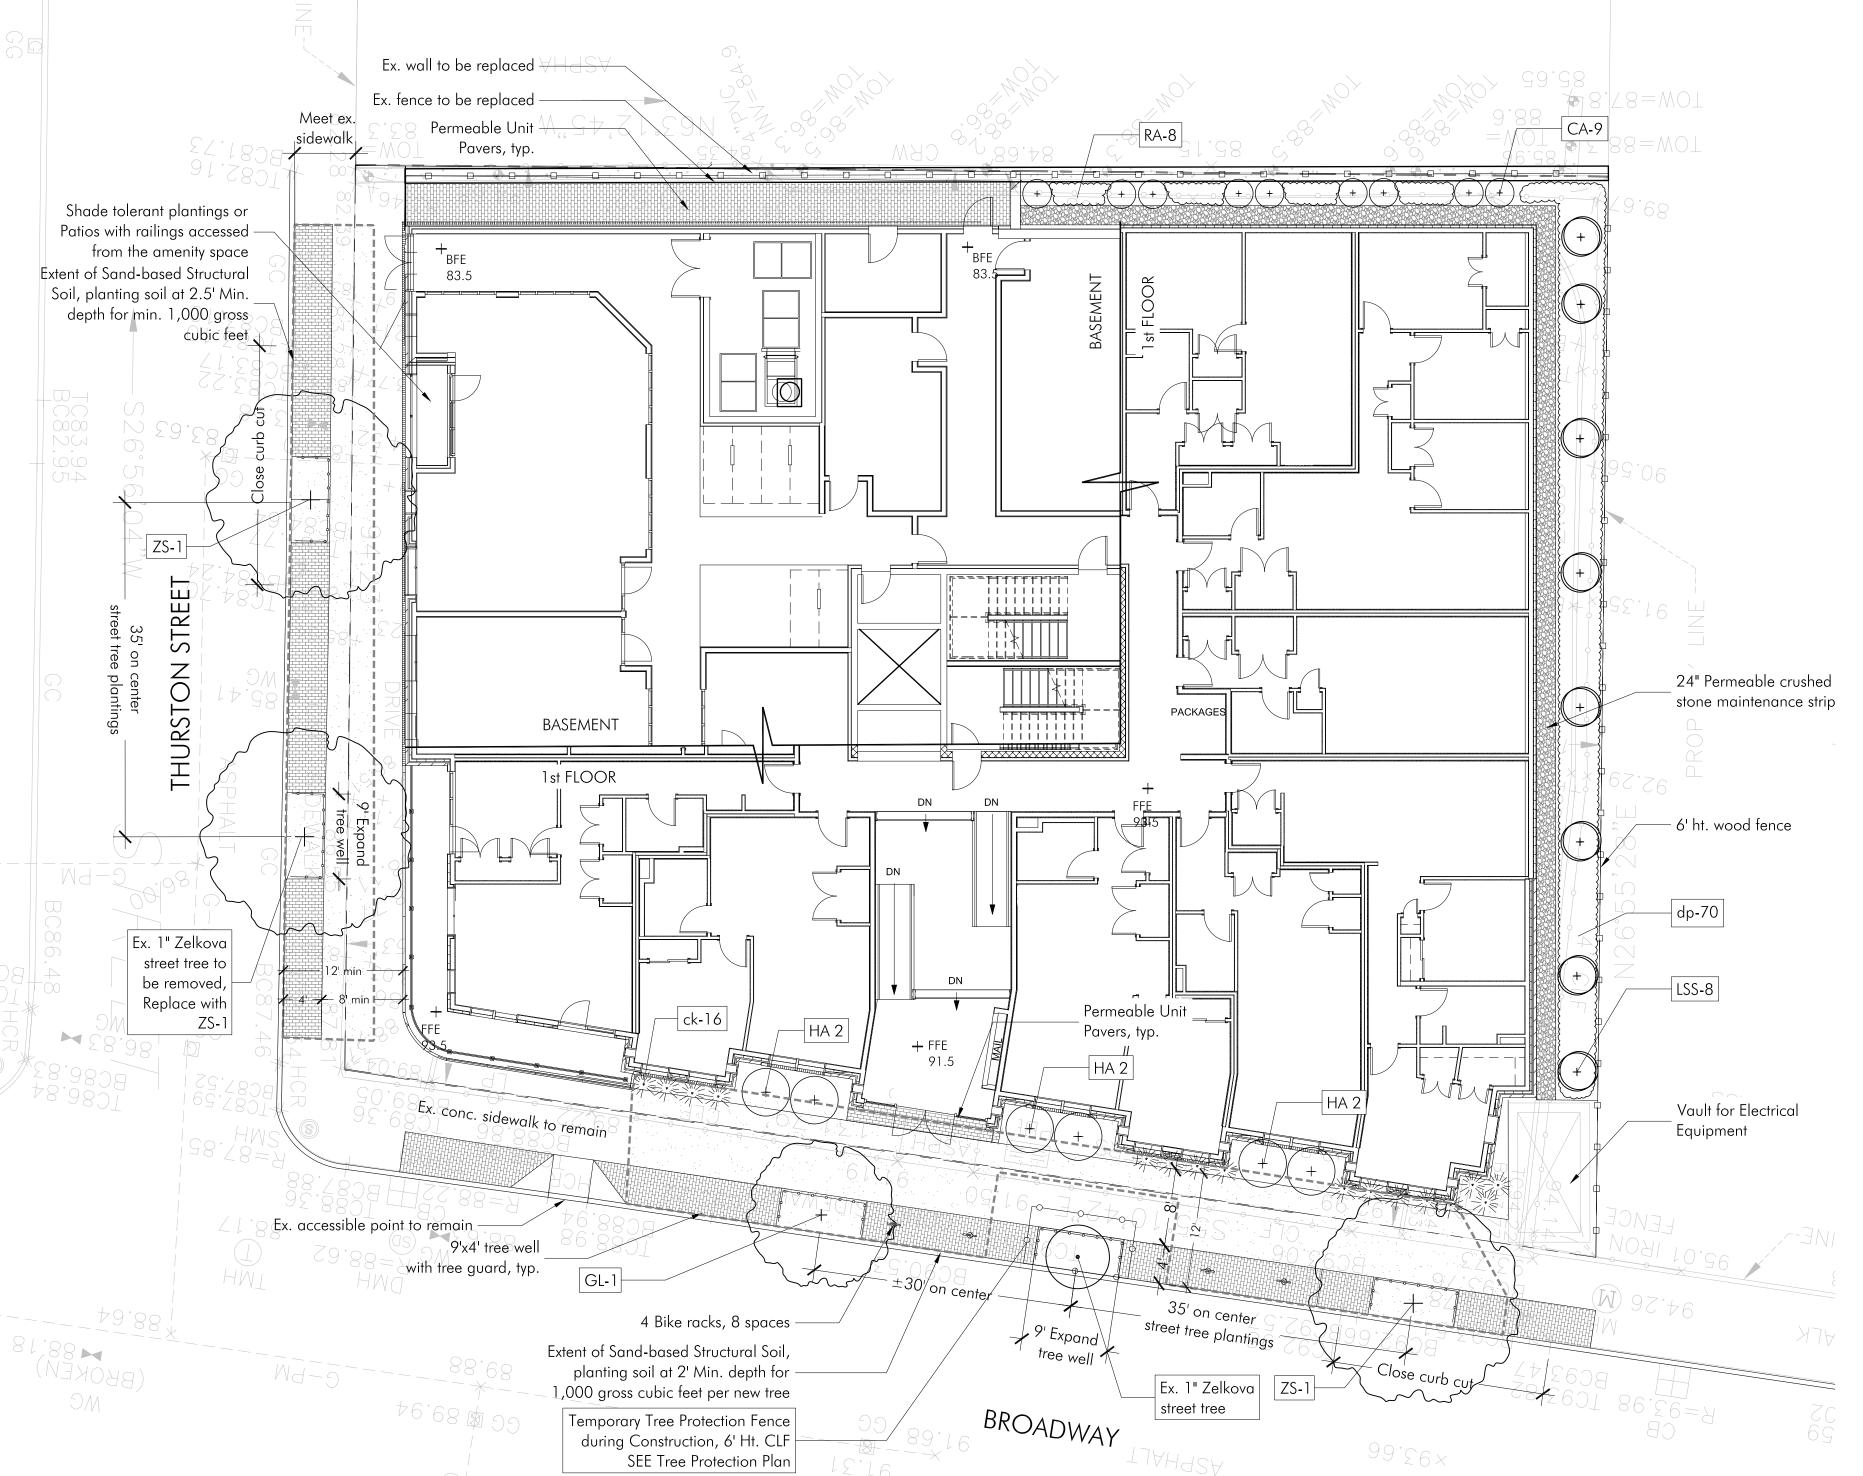


366 BROADWAY SOMERVILLE, MA	LANDSCAPE PLAN

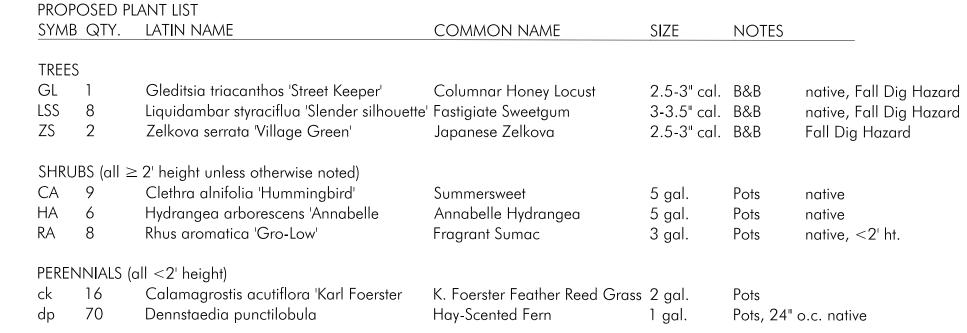Project #:	Date: 03/24/2023
Drawn by: JN	Reviewed: BH
Scale: As noted	

Revisions:

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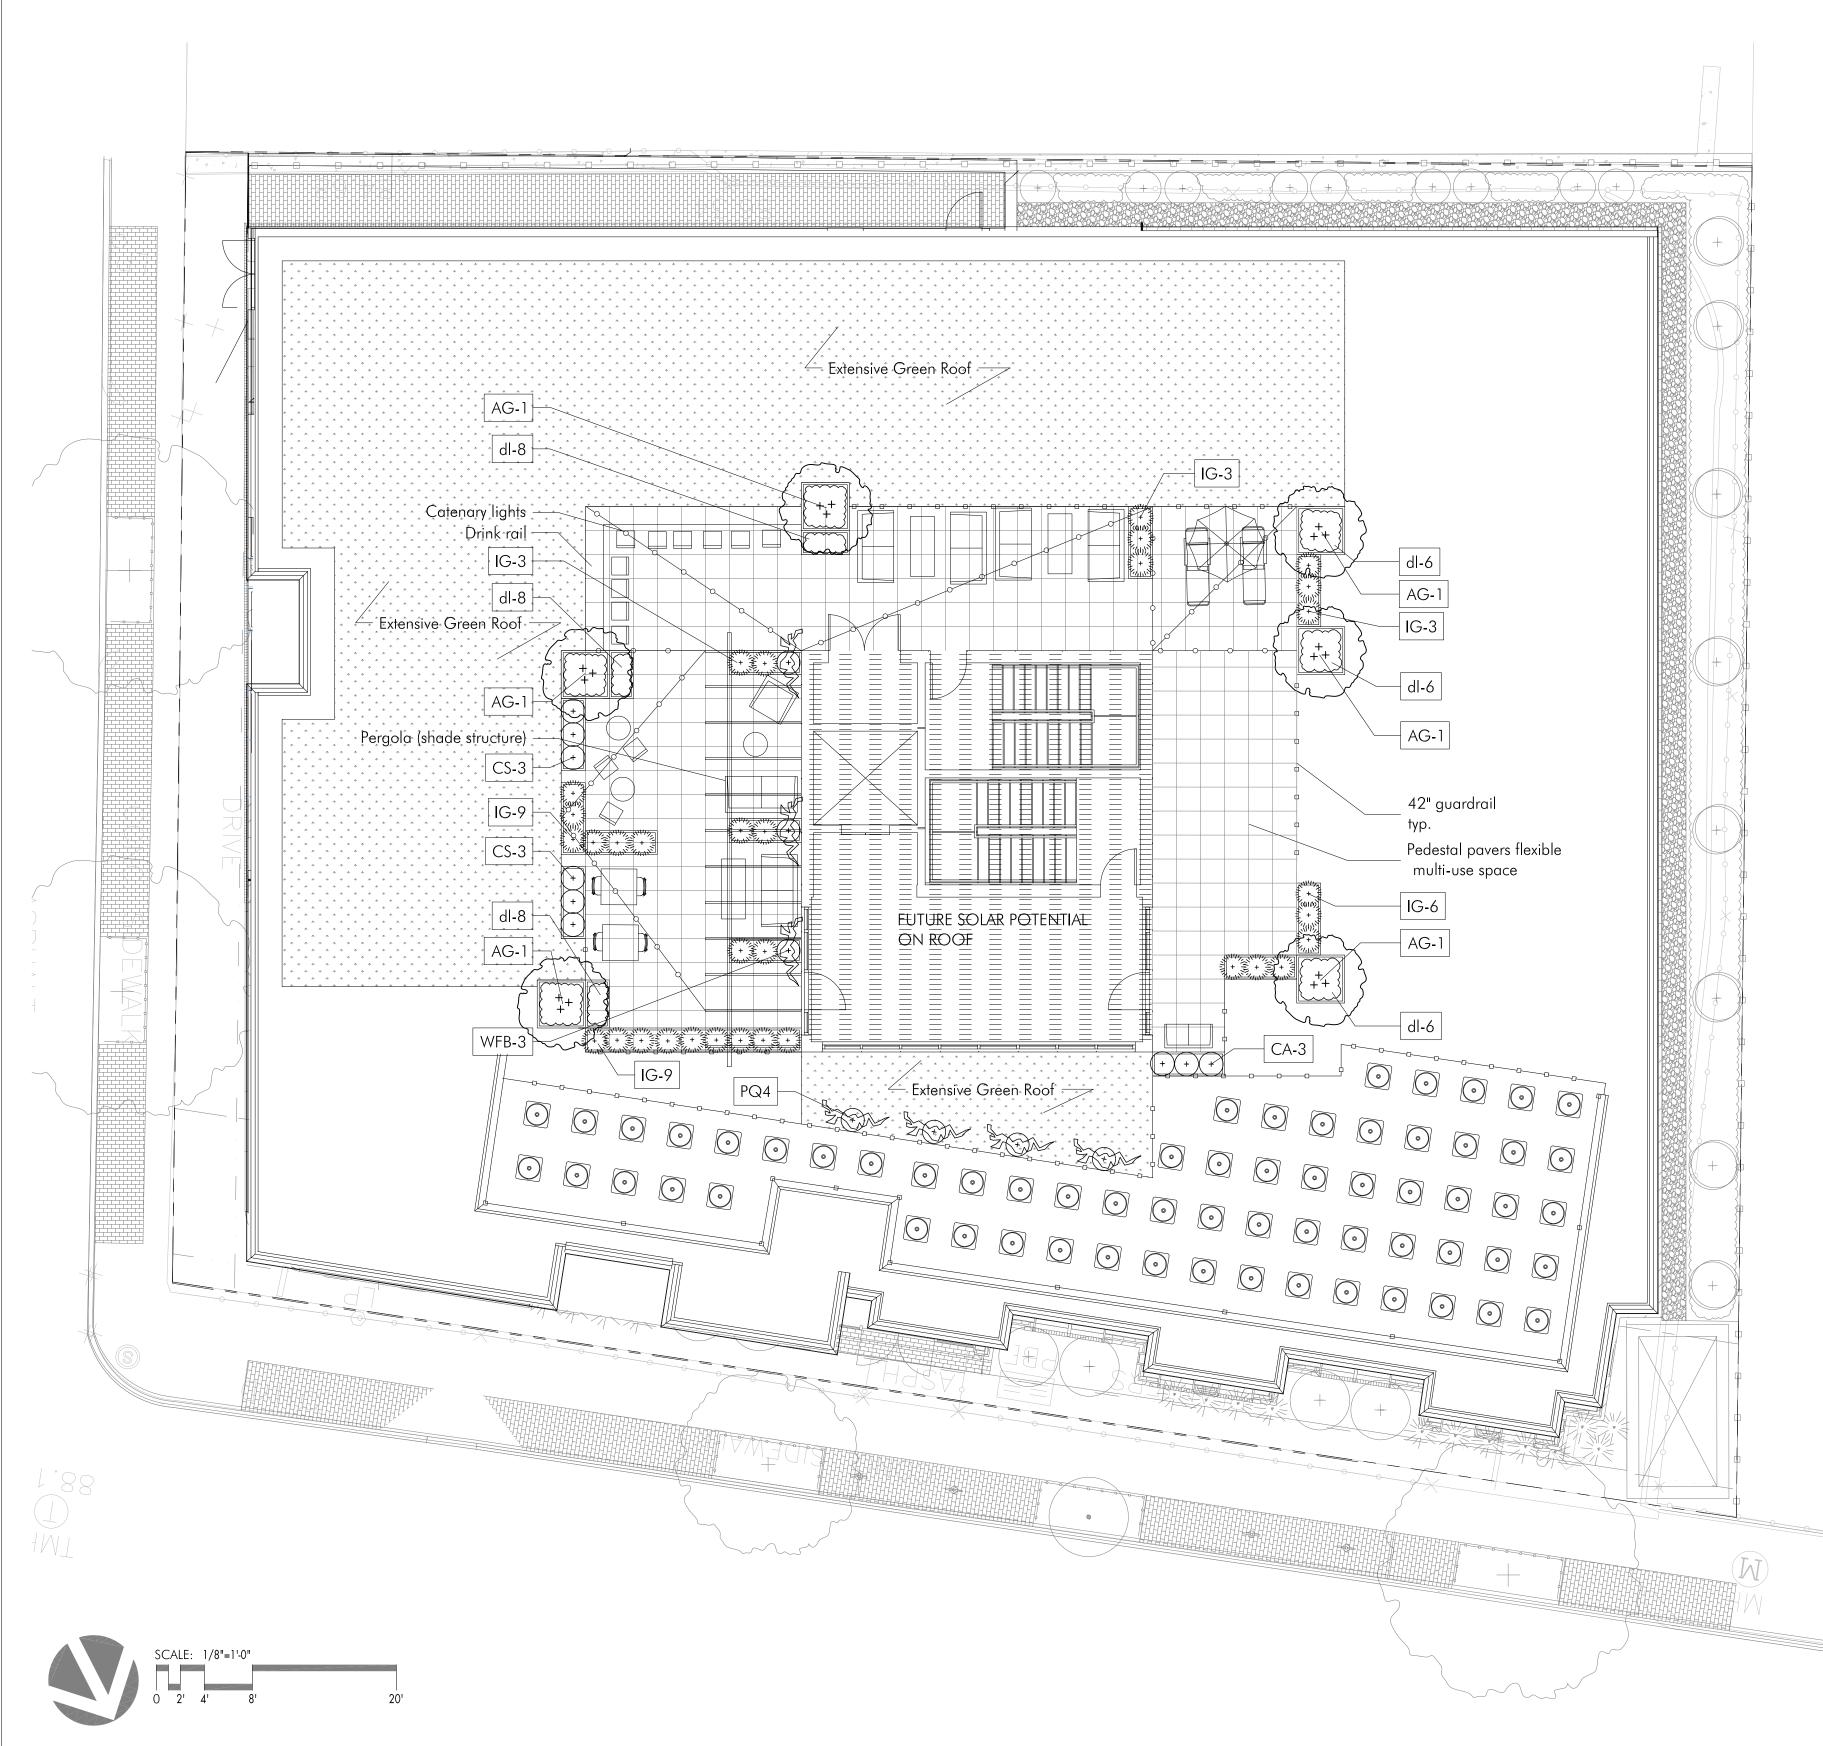






Project #:	Date: 03/23/2023
Drawn by: JN	Reviewed: BH
Scale: As noted	

LRO





318 Harvard Street Brookline, MA 02446 617.735.1180 Verdantla.com 366 Broadway Somerville, MA

March 24, 2023

Dear Andrew, Vanessa, Cortney, and Whomever Else this May Concern,

Please see below our responses to the City review comments received via email in regard to our previous submission, all comments dated March 20, 2023.

From: Andrew Graminski <a href="mailto:square">agraminski@somervillema.gov></a>

Sent: Monday, March 20, 2023 8:46:21 AM

To: Evan Stellman < estellman@tkgeast.com >; Nicholas Zozula < nzozula@mqmllp.com >

Cc: Joseph Hanley < JHanley@mqmllp.com>

Subject: RE: 366 Broadway (P&Z 21-175) - Project Planner Change

Forwarding comments from Vanessa with PSUF:

- 20230317 PSUF vb \*\*COMPLETE\*\* 20230210 PSUF vb City policy is to keep new trees at least 20 feet from crosswalks (see attached planting policy document). It appears that one of the new street trees on Broadway will be closer than 20 feet. Location should be adjusted to maintain 20 feet from crosswalk. This will reduce the spacing between the existing Zelkova and the new one. If spacing will be less than 30 feet, a smaller or narrower species should be planted.
- 20230317 PSUF vb \*\*COMPLETE\*\* 20230210 PSUF vb Tree protection details are required for existing street trees (CK also notes this).
- 20230317 PSUF vb \*\* COMPLETE\*\* 20230210 PSUF vb (recommendation only) Liquidambar stryaciflua 'Slender silhouette' are quite narrow, and could be planted more densely for better screening.
- 20230317 PSUF vb Red maple is very sensitive to salt, and may not do well in this location. Consider Nyssa sylvatica or Honeylocust. Both species have narrow form cultivars if necessary.
- 20230317 PSUF vb New Street Tree Planting with Structural Soil Detail: what is the purpose of the "Continuous 4" perforated pipe around perimeter of tree well..."? If it is for aeration, please omit. If it will be used for watering, then can consider keeping it.
- 20230317 PSUF vb Tree Protection Detail provided on Sheet L8 is acceptable, but layout of protection is not shown on plan. If sidewalk is to remain open to the public during construction, ensure that placement of tree protection does not inhibit sidewalk accessibility.

Andrew Graminski (He/Him)

City of Somerville

From: Andrew Graminski <a href="mailto:sagraminski@somervillema.gov">agraminski@somervillema.gov</a>

Sent: Monday, March 20, 2023 3:13 PM

To: Evan Stellman <estellman@tkgeast.com

Subject: RE: 366 Broadway (P&Z 21-175) - Project Planner Change

Please forward these comments from Cortney Kirk to the landscape team:

- 20230320 PSUF ck Applicant response does not adequately demonstrate that their proposed project will protect the City street trees during construction. Please submit a plan (Tree Protection Plan) of the property and right-of-way with a tree protection fence around each City tree to be protected. 20230207 PSUF ck - Applicant must submit a tree plan with existing to remain trees including a table with species, DPB, health condition and include tree protection details for trees to remain.
- . 20230320 PSUF ck \*\*COMPLETE\*\* 20230207 PSUF ck -- Applicant must submit stamped drawings by a MA Landscape Architect. Submitted landscape drawings are not stamped.
- 20230320 PSUF ck Refer to comments provided by Vanessa Boukili on 20230320 -- 20230207 PSUF ck -- Applicant must submit tree planting details for new street
- . 20230320 PSUF ck \*\*COMPLETE\*\* 20230207 PSUF ck -- Applicant must submit plans that show new street trees are receiving minimum of 1,000 gross cubic feet of planting soil.
- 20230320 PSUF ck Applicant must submit request in writing to the Director of Public Space & Urban Forestry Luisa Oliveira to use structural soils for 366 Broadway -- 20230207 - PSUF ck -- Applicant must request permission to use structural soils if that is the intent of the applicant for the
- 20230320 PSUF ck \*\*COMPLETE\*\* 20230207 PSUF GS ck -- In order to verify green score square footages, applicant must submit landscape drawings at a specified scale. Not to scale (N.T.S.) is not acceptable.
- 20230320 PSUF ck Applicant is still applying bonus credit to both "Plants" categories on the Green Score Card, yet comments from Applicant state they deleted bonus credits. Please identify the bonus credit(s) the Applicant is seeking or properly revise the scorecard. Project does not meet the required score removing bonus from multipliers. 20230207 - PSUF GS ck -- Applicant must identify the bonus credit(s) they are seeking for "Plants" and "Trees."
- 20230320 PSUF ck \*\*COMPLETE, APPLICANT NO LONGER SEEKING "SMALL TREE" CREDIT FOR ROOF\*\* 20230207 PSUF GS ck -- Applicant must submit additional details for trees planted on a roof top. In order for a rooftop tree to receive credit as a "Small Tree" applicant must submit rooftop tree planting details indicating a sufficient amount of soil volume and depth to support the type of tree proposed.
- 20230320 PSUF ck \*\*COMPLETE\*\* 20230207 PSUF GS ck -- It is not clear where the permeable pavement is that the applicant is seeking credit for. Please note where permeable pavement is on the landscape plans.

Thanks,

Andrew Graminski (He/Him)

City of Somerville

From: Andrew Graminski < agraminski@somervillema.gov>

Sent: Monday, March 20, 2023 4:17 PM
To: Evan Stellman <<u>estellman@tkgeast.com</u>>
Cc: Nicholas Zozula <<u>nzozula@mgmllp.com</u>>
Subject: FW: 366 Broadway - Plan Set

FYI

### Andrew Graminski (He/Him)

### Planner

City of Somerville

 $Office\ of\ Strategic\ Planning\ \&\ Community\ Development-Planning,\ Preservation,\ and\ Zoning\ Division$ 

3rd Floor City Hall, 93 Highland Avenue Somerville, Massachusetts 02143 agraminski@somervillema.gov

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From: Vanessa Boukili < vboukili@somervillema.gov>

Sent: Monday, March 20, 2023 3:44 PM

To: Andrew Graminski <a href="mailto:sgraminski@somervillema.gov">sgraminski@somervillema.gov</a>

Cc: Cortney Kirk < ckirk@somervillema.gov>
Subject: Re: 366 Broadway - Plan Set

Hi Andrew,

I just drove by this location, and the recently planted Japanese Zelkova on the Thurston side of the property is broken (probably hit by a vehicle). The applicant will no longer need to protect this dead/nearly dead tree, but they should plan to plant a new tree here. It can match the specs of the other new trees they are installing.

Best, Vanessa

Sent from my iPhone

### VLA Responses as follows:

- The Acer rubrum has been revised to a Columnar Honey Locust (Street Keeper cultivar) see Sheet L1 for revised plant schedule.
- New Street Tree Planting detail has been revised with note: 'if permanent irrigation is not provided, the perforated pipe as noted is to be provided.' Applicant/design team to verify during DD/CD phases.
- Layout of Tree Protection Fencing has been added to the Landscape Plan please refer to Sheet L1. Additional information has been provided in Tree Protection Plan – see below comment
- Please refer to the Tree Protection Plan now included in the revised Landscape Set dated 03/24/23, including: layout of tree protection fencing at existing tree within ROW, table noting species/DBH/health condition of existing trees, and tree protection detail. As observed in additional email from Vanessa, the existing Zelkova along Thurston Street has been damaged and is now noted as to be removed. See Sheet L9
- Please refer to letter from applicant requesting use of structural soils included in additional submission materials.
- Scorecard has been revised to omit all bonus credits, including credits previously noted for 'Plants' categories see Revised Landscape Set dated 03/24/23.


Sincerely,

Verdant Landscape Architecture, Inc.

Erin Hossaini-Fitch LEED Green Associate Associate Project Manager


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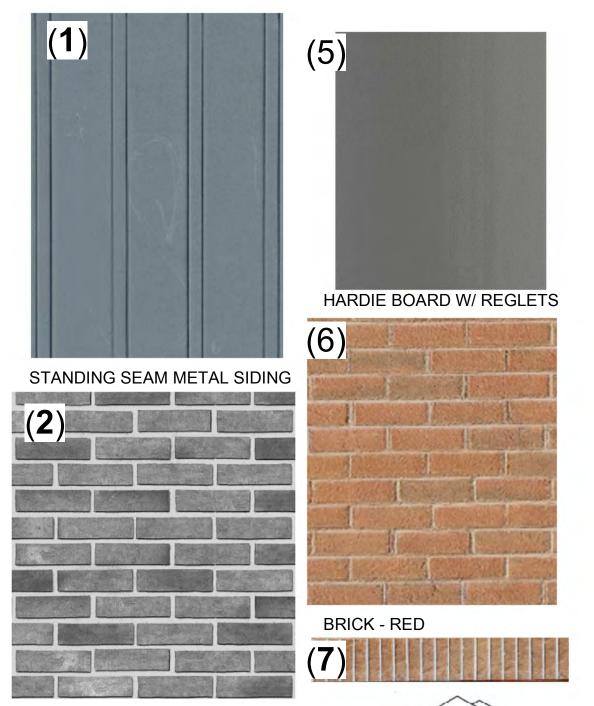
Diagrammatic Section & Bldg Metrics

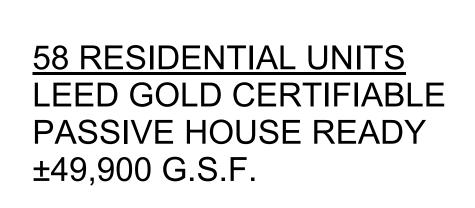



4 STORIES OF TYPE 5A (2,3,4,R) OVER 1 STORY TYPE 1A CONSTRUCTION (1ST + BASEMENT)


1 ELEVATOR CENTRAL CORE STAIR LAYOUT: CORRIDOR WALLS REQUIRE SAME FIRE RATING AS STAIR




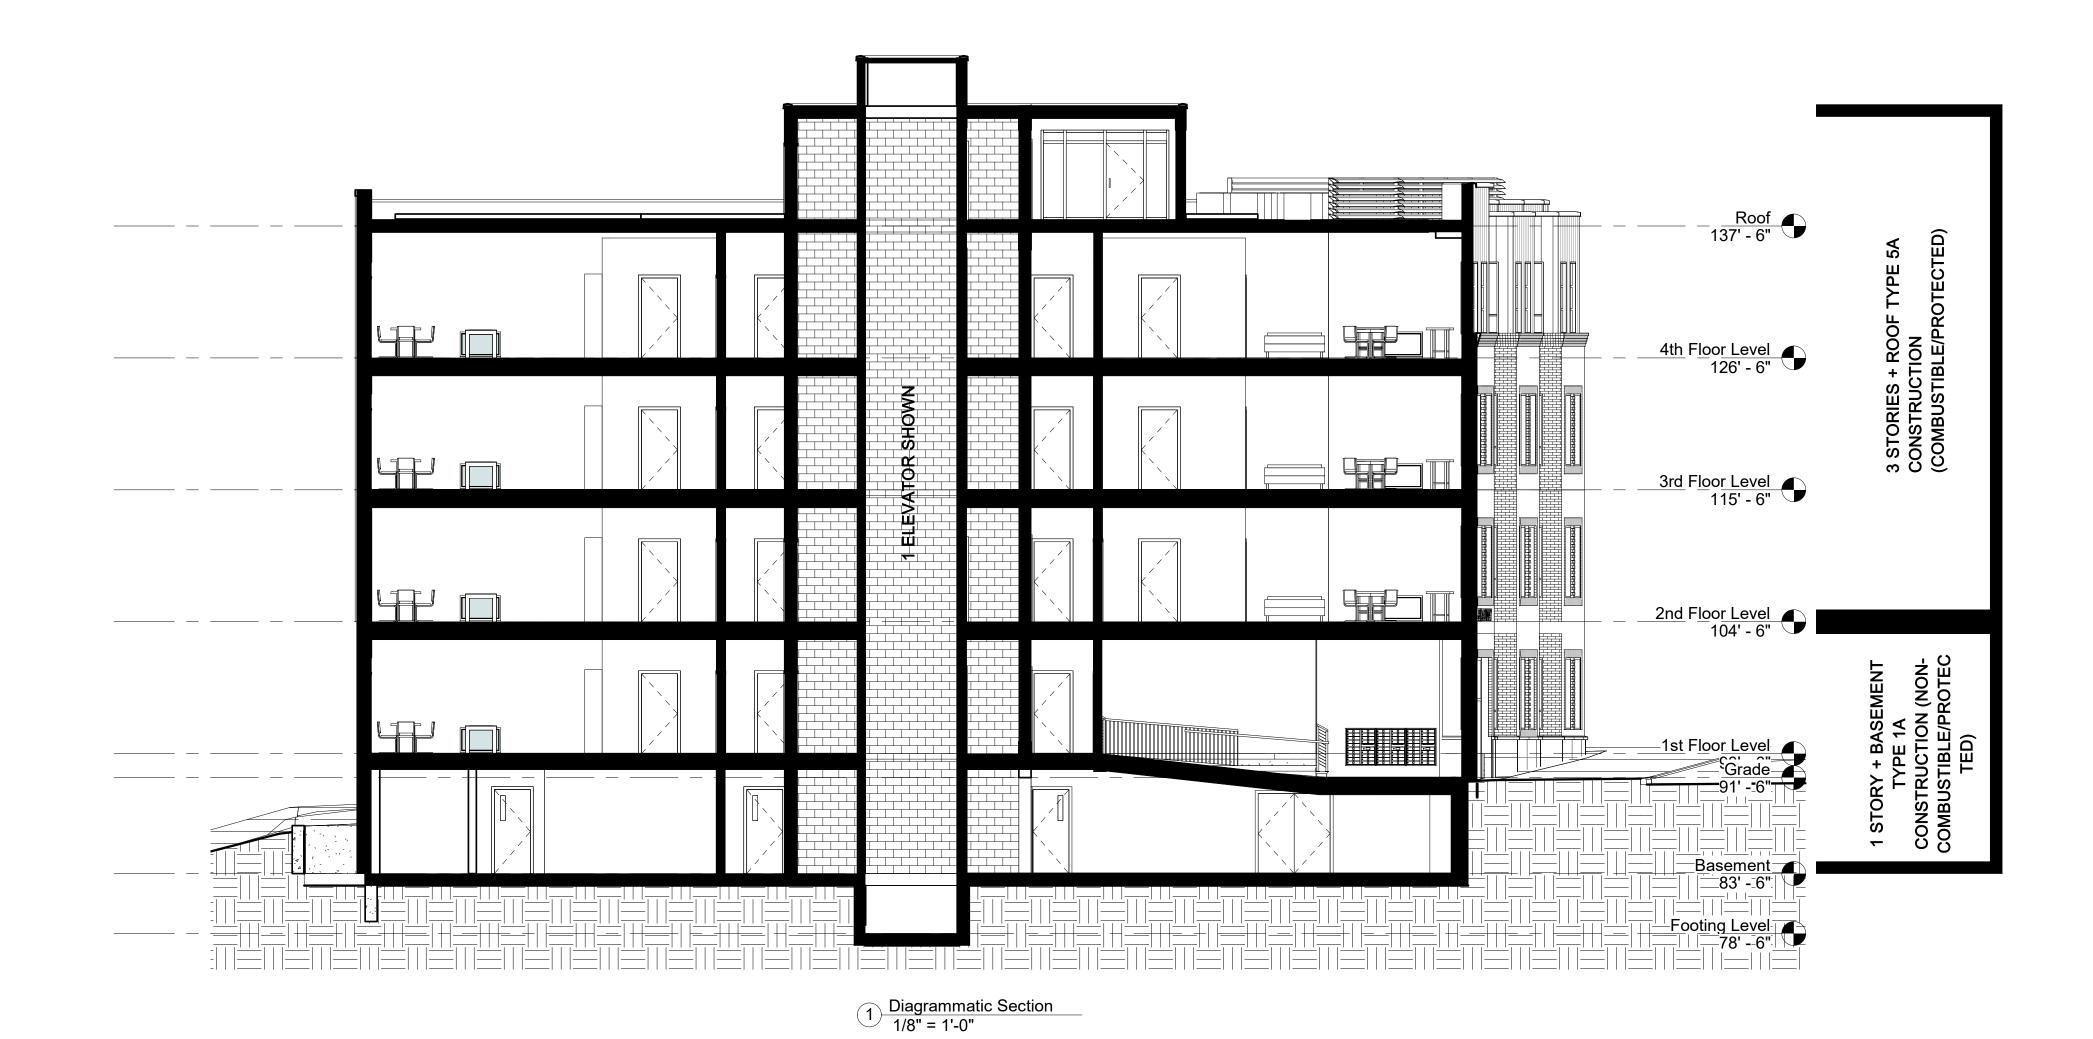

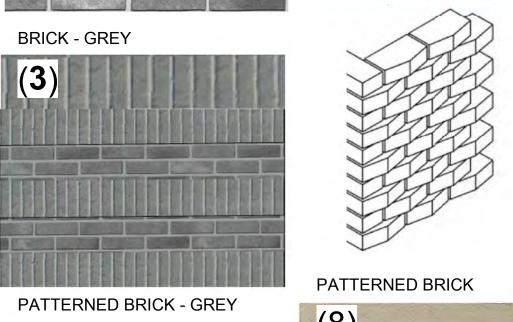

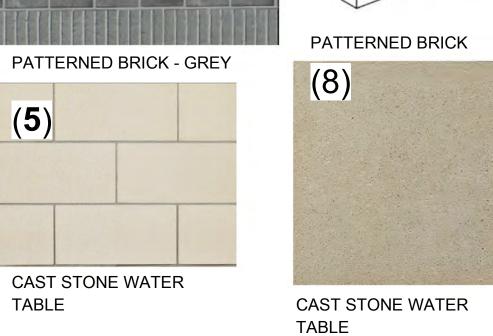

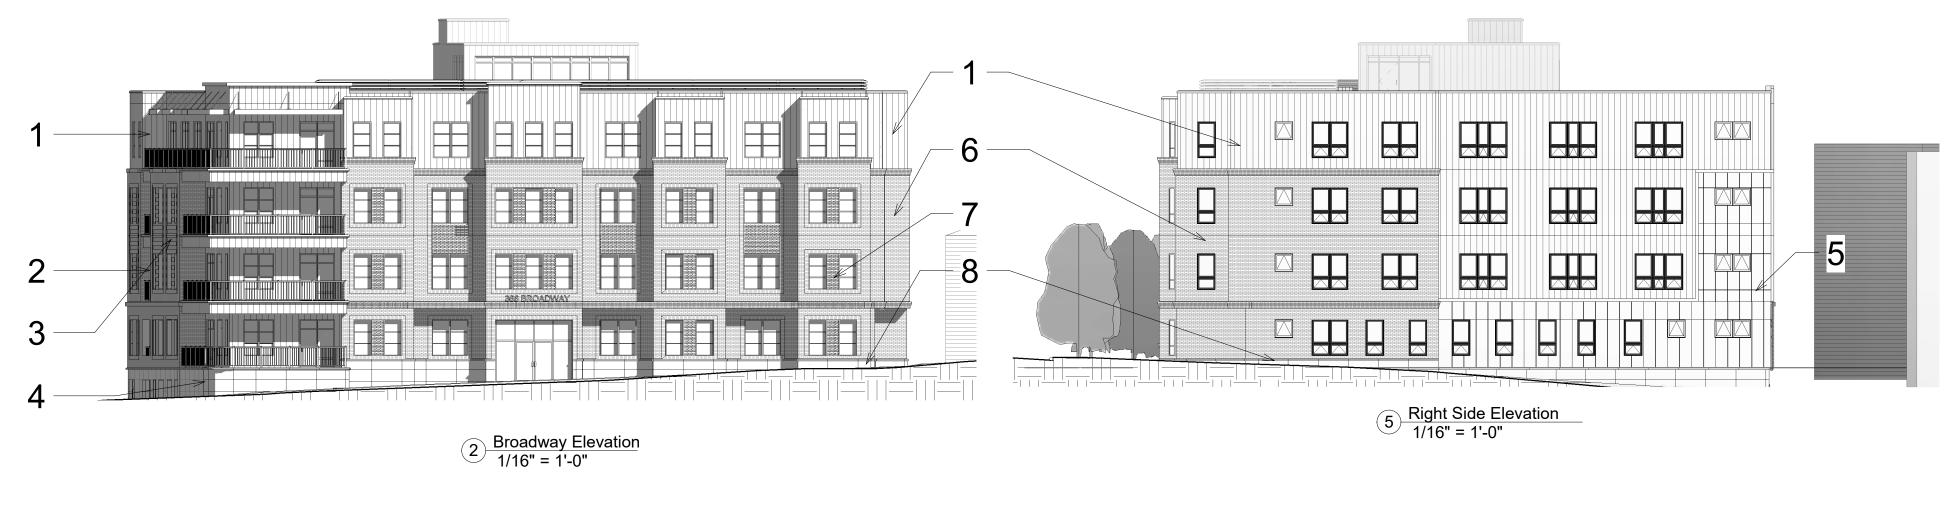

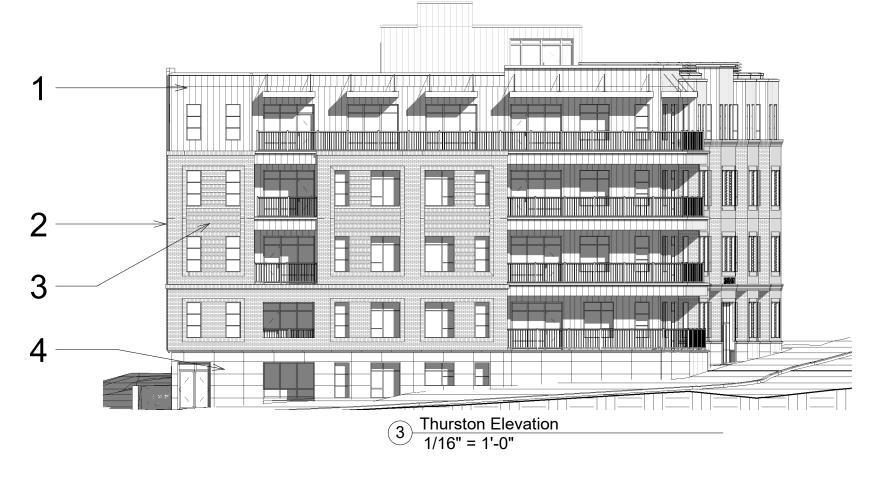



PROJECT NAME

**366 Broadway** Residences

366 Broadway Somerville, MA

366 Broadway Somerville LLC



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Site Plan

**A-020** 



PROJECT ADDRESS

PROJECT NAME

366 Broadway Somerville, MA

CLIENT

366 Broadway Somerville LLC

## ARCHITECT




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Gross Floor Area

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366 Broadway Residences



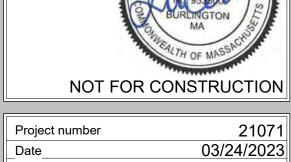


Building GFA

Basement 1/16" = 1'-0"

4 3rd Floor Level 1/16" = 1'-0" 6577 SF

Building GFA


10642 SF

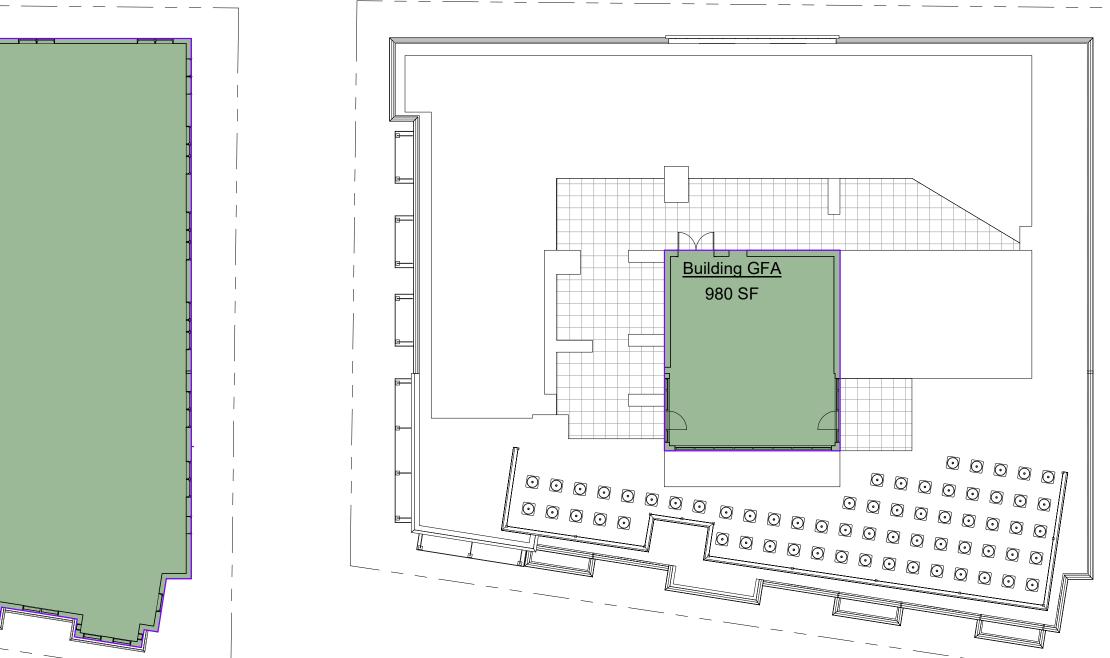

6 Roof 1/16" = 1'-0"

Gross Building Area			
Name	Area	Level	
Building GFA	10676 SF	1st Floor Level	
Building GFA	10646 SF	2nd Floor Level	
Building GFA	10642 SF	3rd Floor Level	
Building GFA	10434 SF	4th Floor Level	
Building GFA	6577 SF	Basement	
Building GFA	980 SF	Roof	
	49954 SF	'	

49954 SF BUILDING DENSITY: 49,954
49954 SF NET ZERO READY (/850 S.F. PER DU) = 58 UNITS

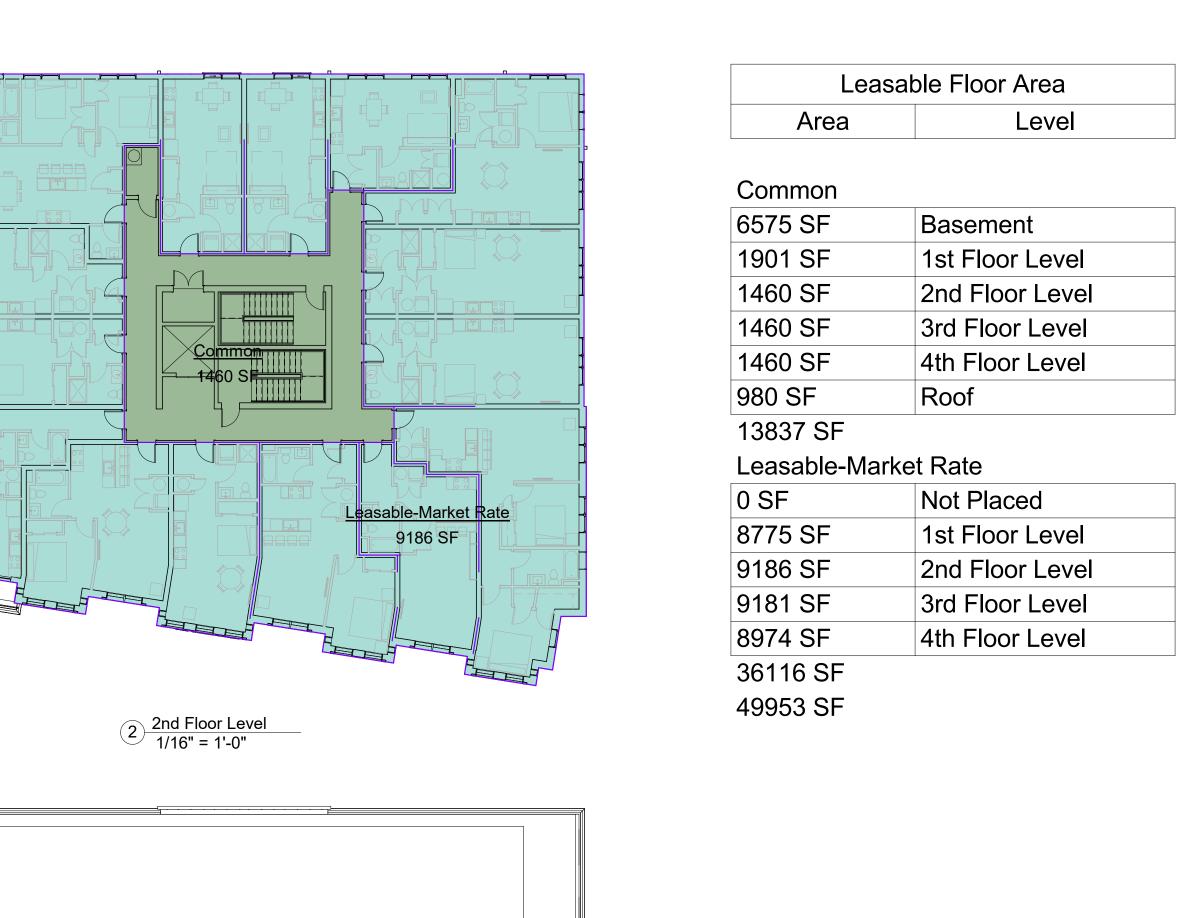

Common 980 SF

6 Roof 1/16" = 1'-0"

Leasable-Market Rate

8775 SF

1st Floor Level 1/16" = 1'-0"

8974 SF


4th Floor Level 1/16" = 1'-0"

6575 SF

5 Basement 1/16" = 1'-0"

easable-Market Rate 9181 SF

3 3rd Floor Level 1/16" = 1'-0"

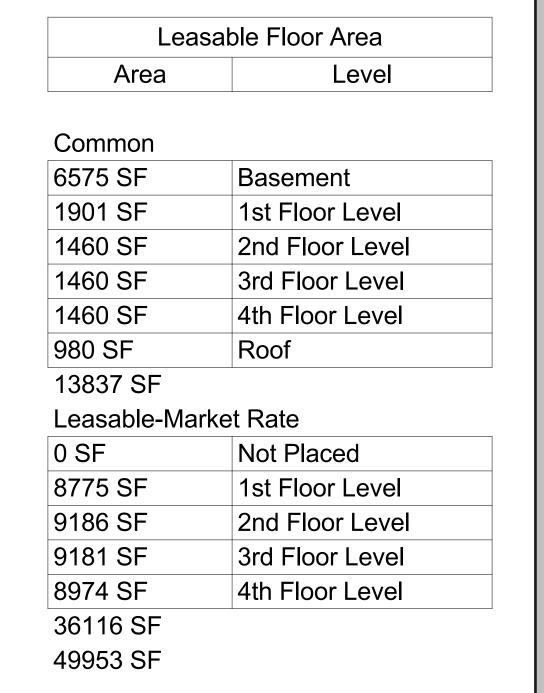



PROJECT NAME

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366 Broadway

Residences

366 Broadway

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Leasable Floor Area

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PROJECT NAME 366 Broadway Residences PROJECT ADDRESS 366 Broadway Somerville, MA CLIENT ARCHITECT CONSULTANTS: REGISTRATION

90 SF

MEP 183 SF

Circulation 1742 SF

MEP 374 SF

MEP 554 SF

UNEXCAVATED

258 SF

Bike Storage 117 SF

BICYCLE Bike Storage
REPAIR 137 SF
STATION

Leasing 171 SF

Amenities 739 SF

Amenities 823 SF

366 Broadway Somerville LLC



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**Basement Floor** Plan

366 Broadway Residences

366 Broadway Somerville, MA

366 Broadway Somerville LLC



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1st Floor Plan

PROJECT NAME 366 Broadway

Residences

PROJECT ADDRESS 366 Broadway Somerville, MA

CLIENT

366 Broadway Somerville LLC

ARCHITECT



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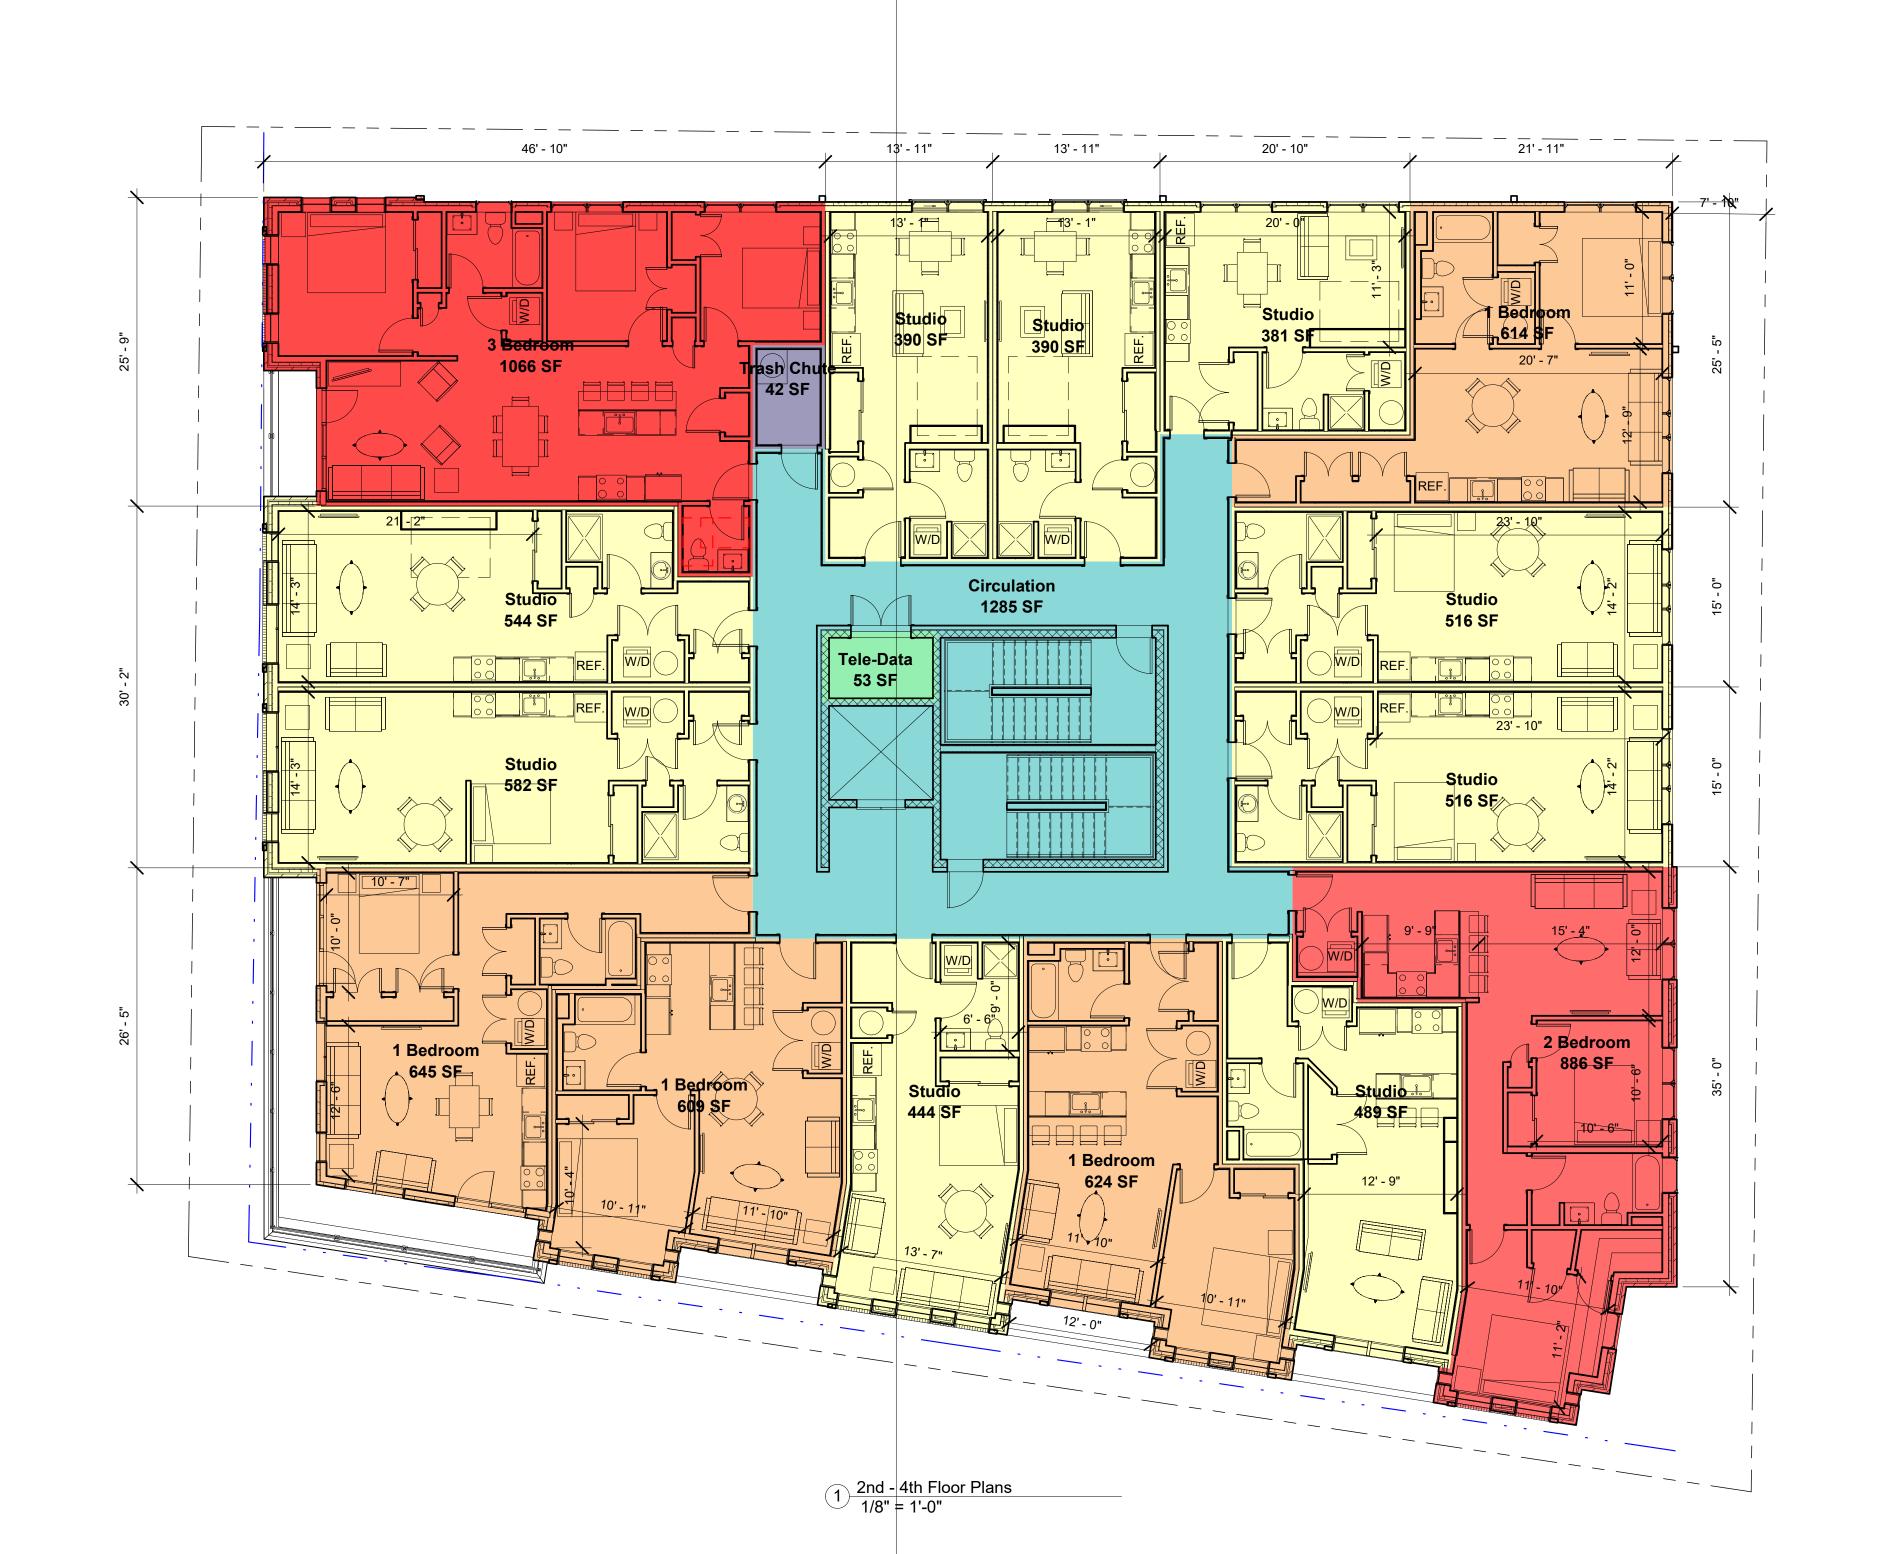
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2nd - 4th Floor Plans



	UNIT BREAKDOWN BY FLOOR						
FLOOR	STUDIO	1 BEDROOM	2 BEDROOM	3 BEDROOM	TOTAL	COMMENTS	
1	6	4	2	1	13		
2	9	4	1	1	15		
3	9	4	1	1	15		
4	9	4	1	1	15		
TOTAL	33 (57%)	16 (27%)	5 (9%)	4 (7%)	58		

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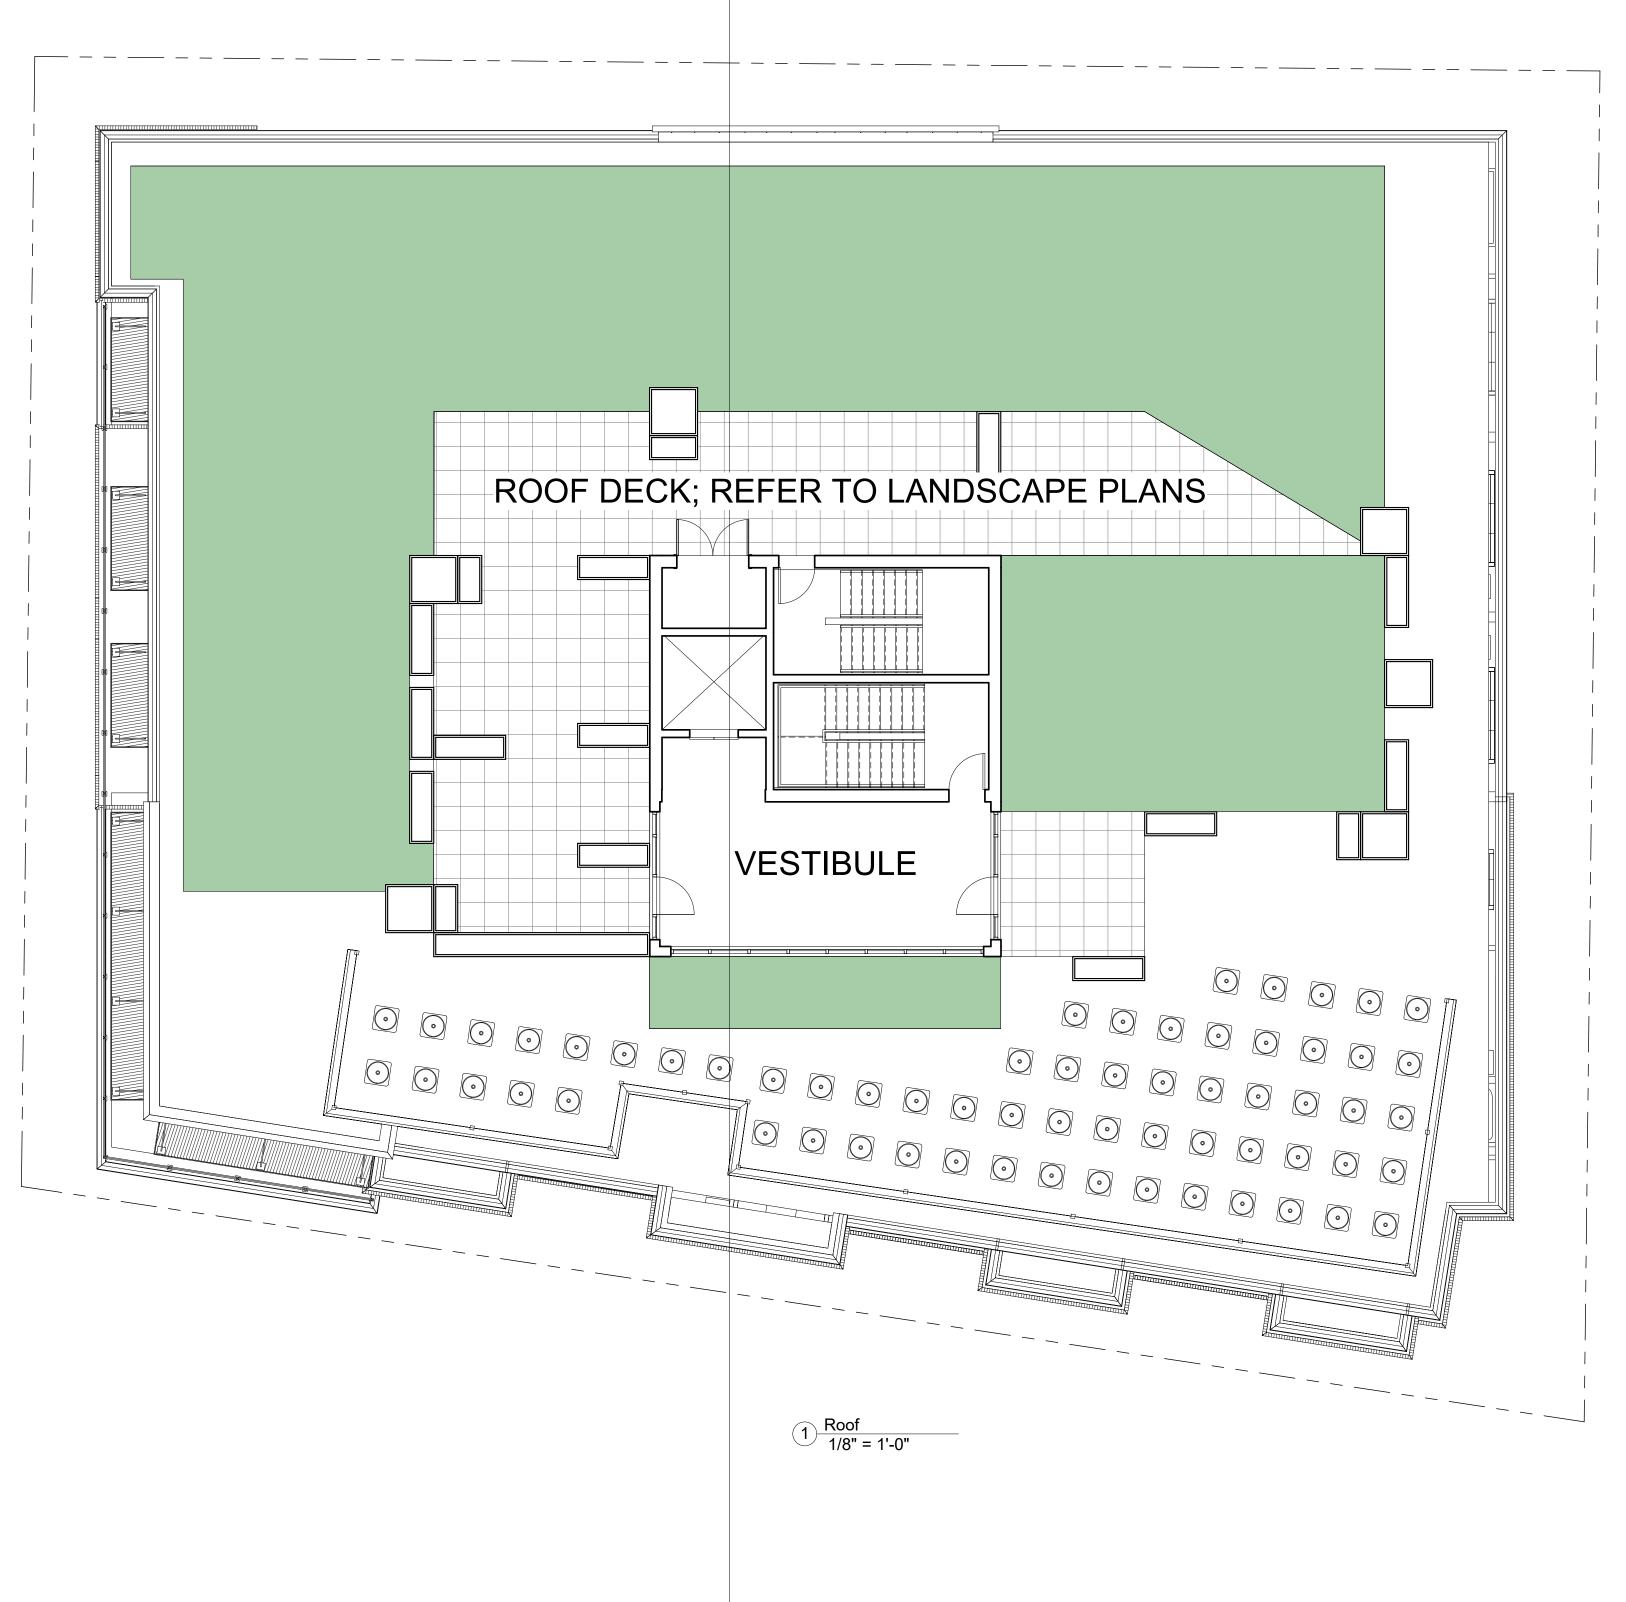
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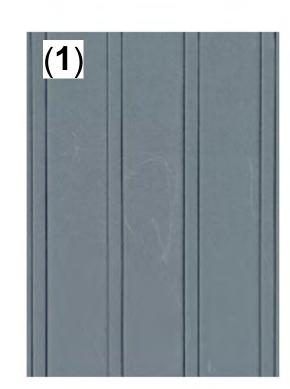
Roof Plan

A-103 366 Broadway Residences




		UNIT	BREAKDOWN B	Y FLOOR		
FLOOR	STUDIO	1 BEDROOM	2 BEDROOM	3 BEDROOM	TOTAL	COMMENTS
1	6	4	2	1	13	
2	9	4	1	1	15	
3	9	4	1	1	15	
4	9	4	1	1	15	
TOTAL	33 (57%)	16 (27%)	5 (9%)	4 (7%)	58	






STANDING SEAM METAL SIDING

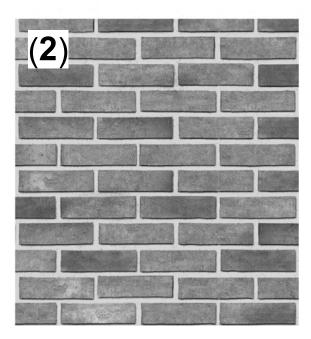

**BRICK - GREY** 

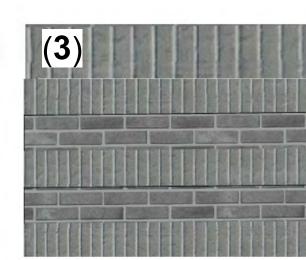

PATTERNED BRICK - GREY





CAST STONE WATER TABLE






Primary Front (Broadway) Elevation 1/8" = 1'-0"

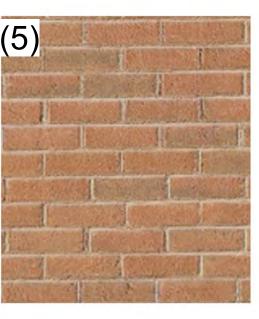

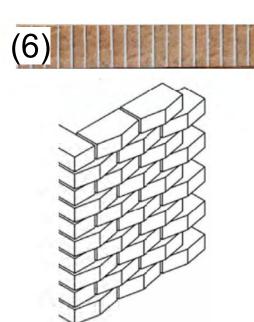


PATTERNED BRICK

CAST STONE WATER TABLE

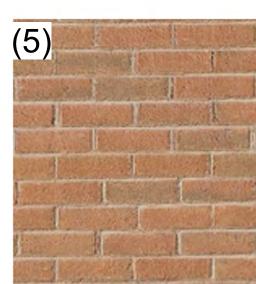


BRICK - RED

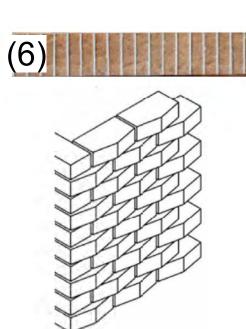



Grade 91' - 6"

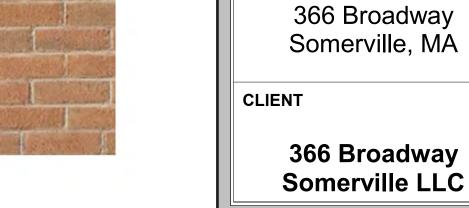



PROJECT NAME

PROJECT ADDRESS

366 Broadway


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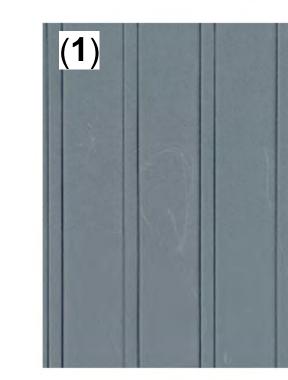


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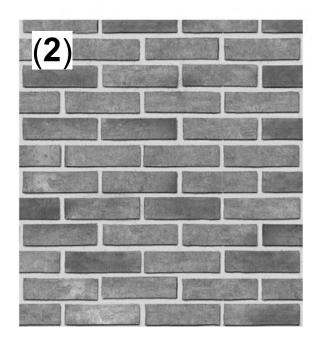
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Primary Front Elevation -Broadway






STANDING SEAM METAL SIDING

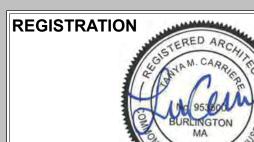

**BRICK - GREY** 

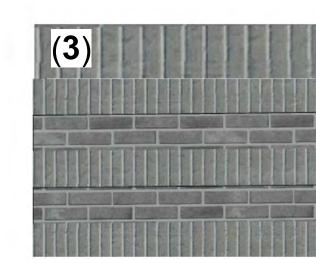


PATTERNED BRICK - GREY




CAST STONE WATER TABLE




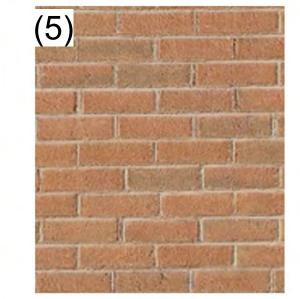


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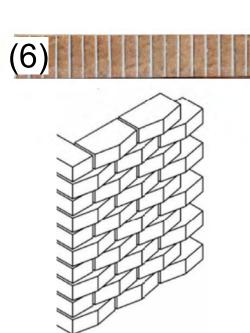


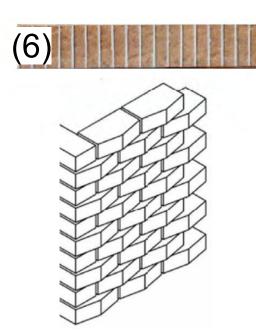PATTERNED BRICK

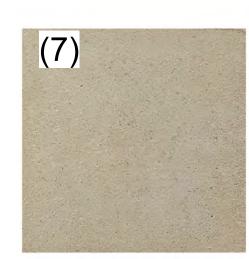

CAST STONE WATER TABLE



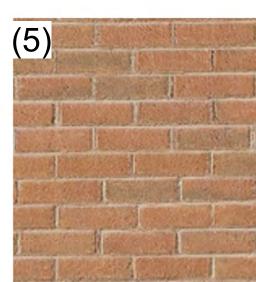





366 Broadway Residences

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PROJECT NAME

366 Broadway Somerville, MA

CLIENT


366 Broadway Somerville LLC

## ARCHITECT




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Secondary Front Elevation-Thurston

A-302 366 Broadway Residences

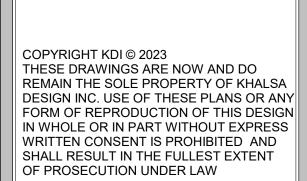

PROJECT NAME

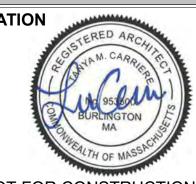366 Broadway Residences

PROJECT ADDRESS

366 Broadway Somerville, MA

CLIENT

366 Broadway Somerville LLC

ARCHITECT



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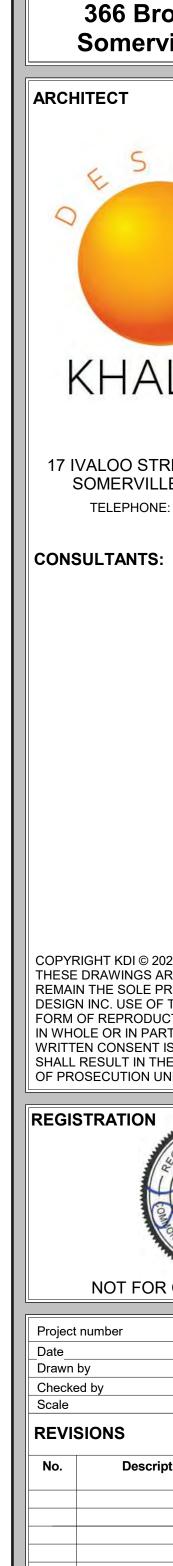
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Side Elevations

A-303
366 Broadway Residences





PROJECT NAME

366 Broadway Residences

PROJECT ADDRESS

366 Broadway Somerville, MA

CLIENT

366 Broadway Somerville LLC



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21071 03/24/2023 ERS JSK

NI -	December 41 and	D-4-
No.	Description	Date

Perspective at Broadway & Thurston

AV-1 366 Broadway Residences

CLIENT

PROJECT NAME

366 Broadway Somerville LLC

## ARCHITECT



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## REGISTRATION



21071 03/24/2023 ERS JSK Project number Date\_ Drawn by Checked by

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Perspective at Broadway

**AV-2** 366 Broadway Residences



CLIENT

366 Broadway Somerville LLC

## ARCHITECT




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## REGISTRATION



21071 Project number 03/24/2023 Author Checker Drawn by Checked by Scale

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No.	Description	Date				

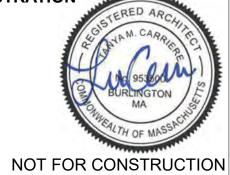Thurston Street Perspective

AV-3 366 Broadway Residences



PROJECT NAME

366 Broadway Residences

PROJECT ADDRESS

366 Broadway Somerville, MA

CLIENT

366 Broadway Somerville LLC

ARCHITECT



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REGISTRATION

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Proposed Rendering

PROJECT NAME 366 Broadway Residences

PROJECT ADDRESS

366 Broadway Somerville, MA

CLIENT

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ARCHITECT



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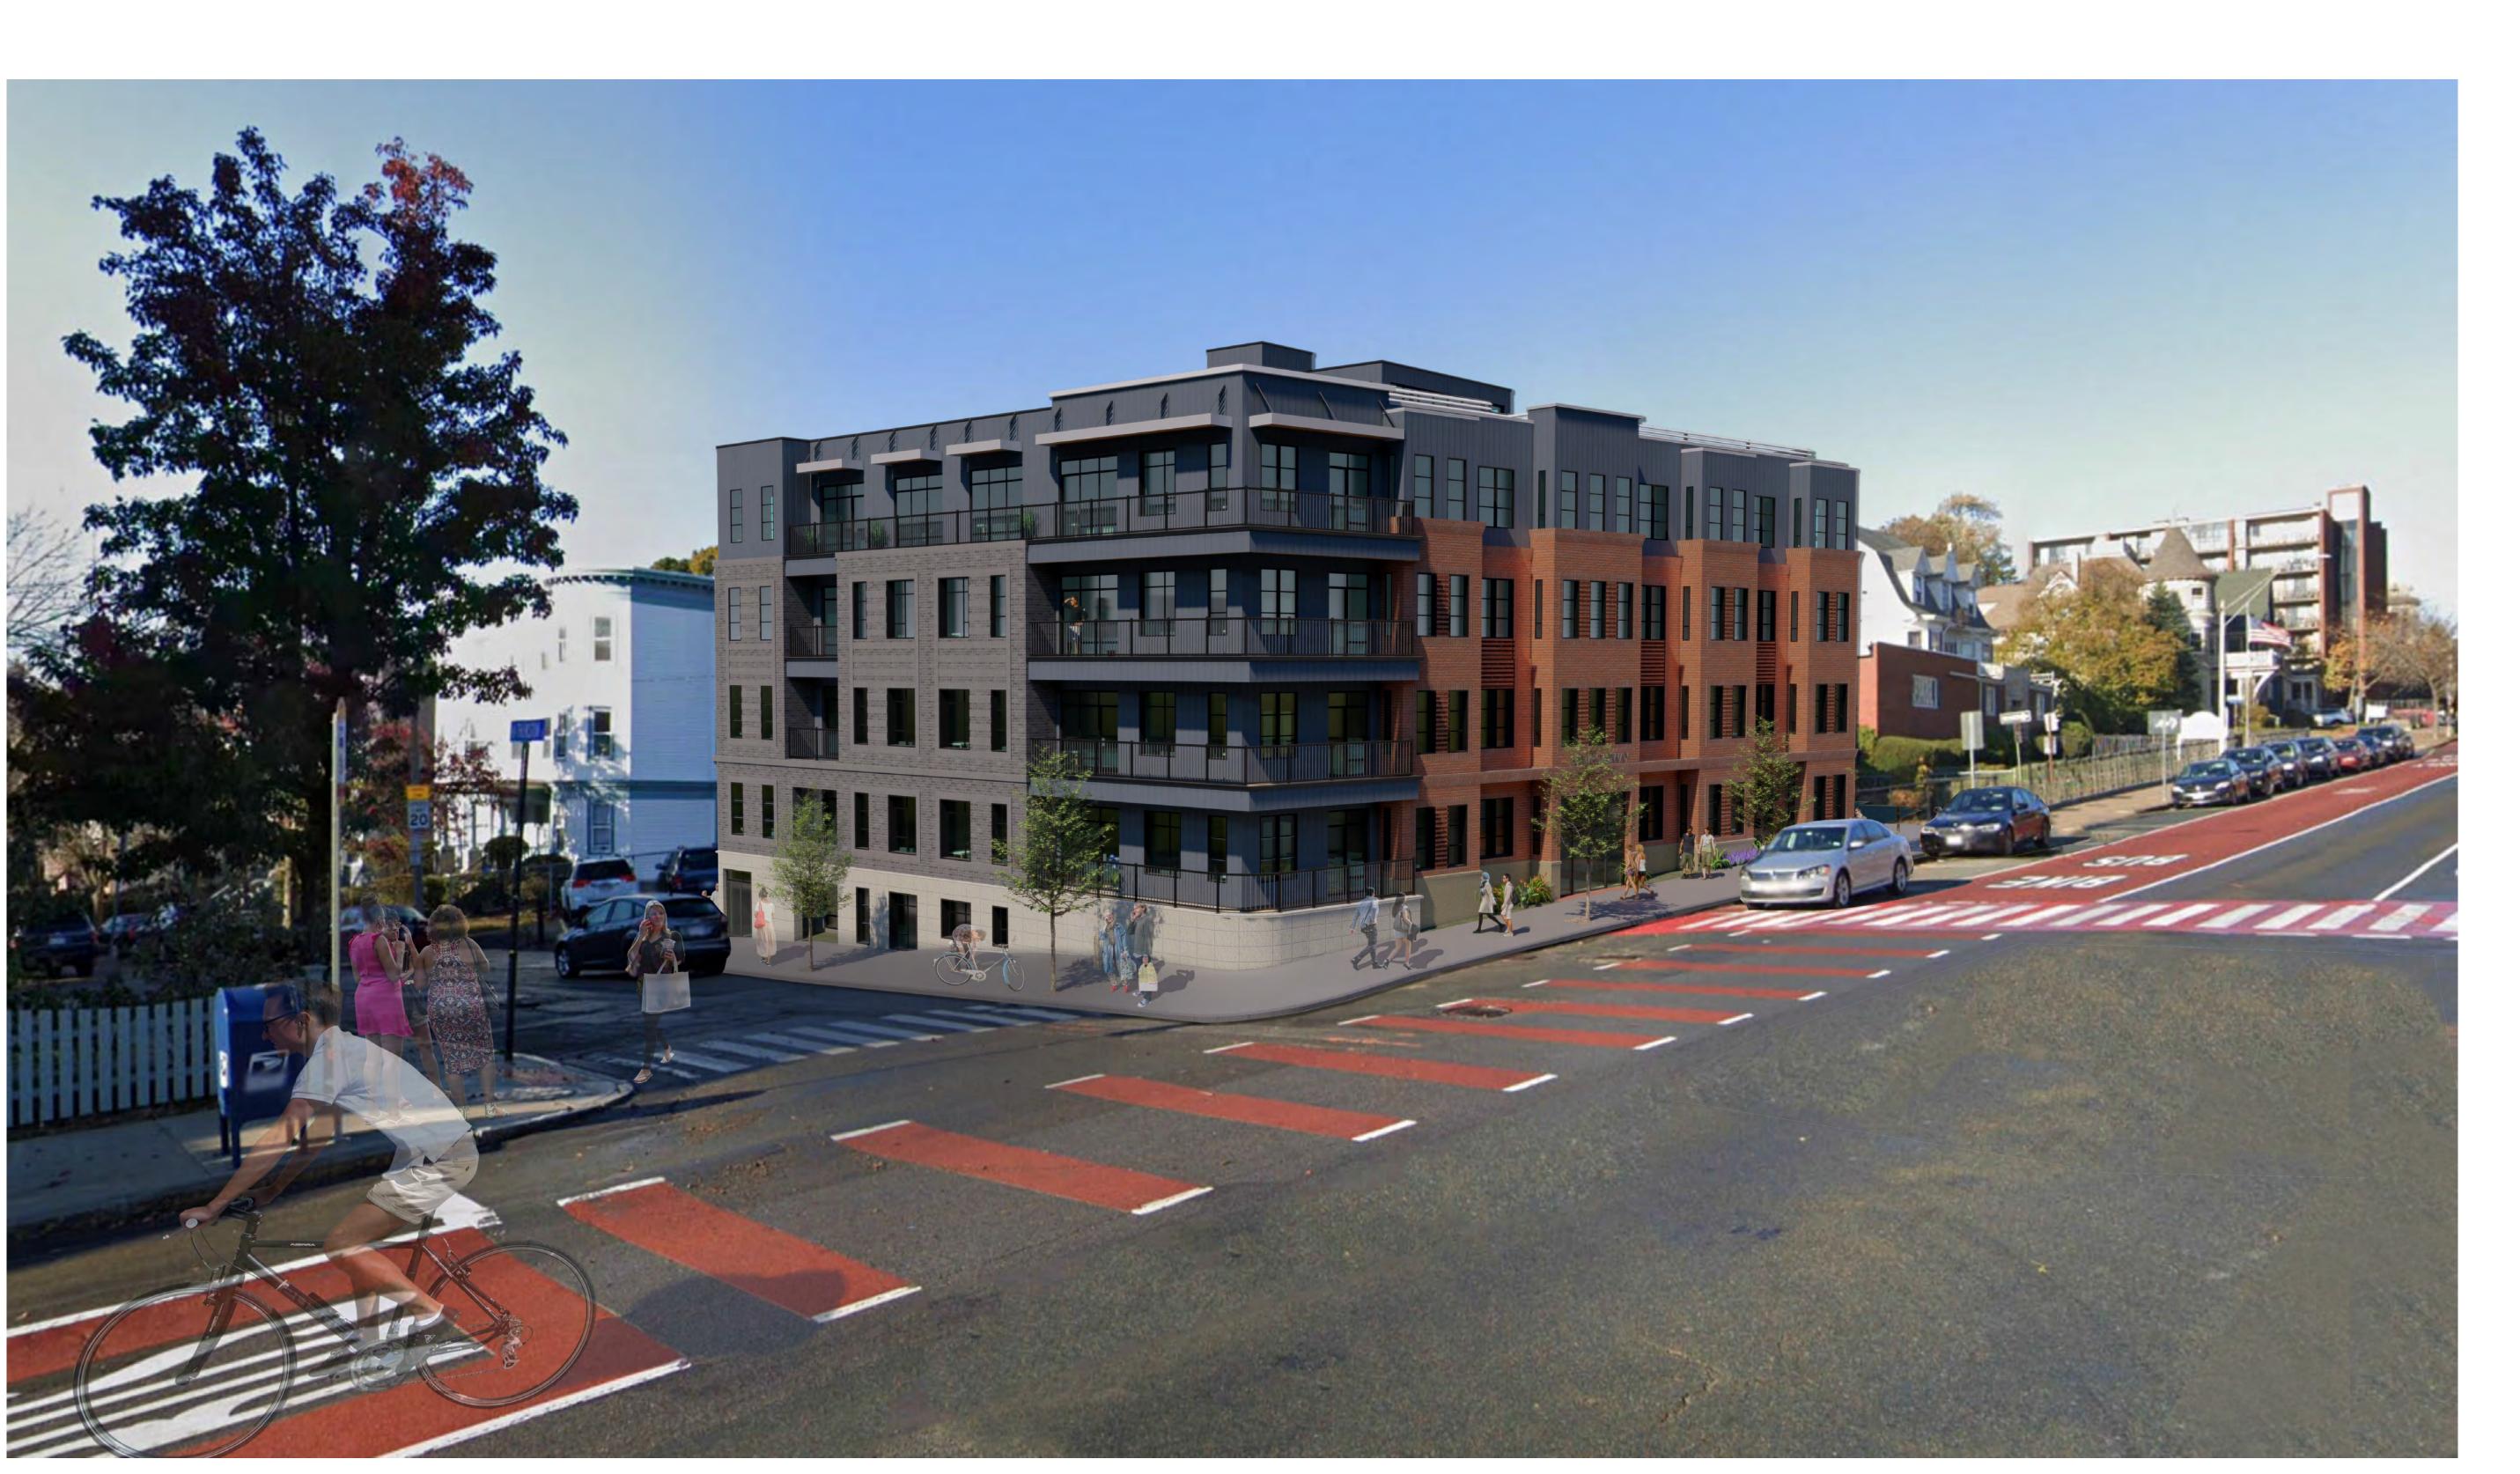
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Proposed Rendering





366 Broadway Residences PROJECT ADDRESS 366 Broadway Somerville, MA

PROJECT NAME

CLIENT

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Proposed Aerial



PROJECT NAME 366 Broadway Residences PROJECT ADDRESS 366 Broadway Somerville, MA

CLIENT

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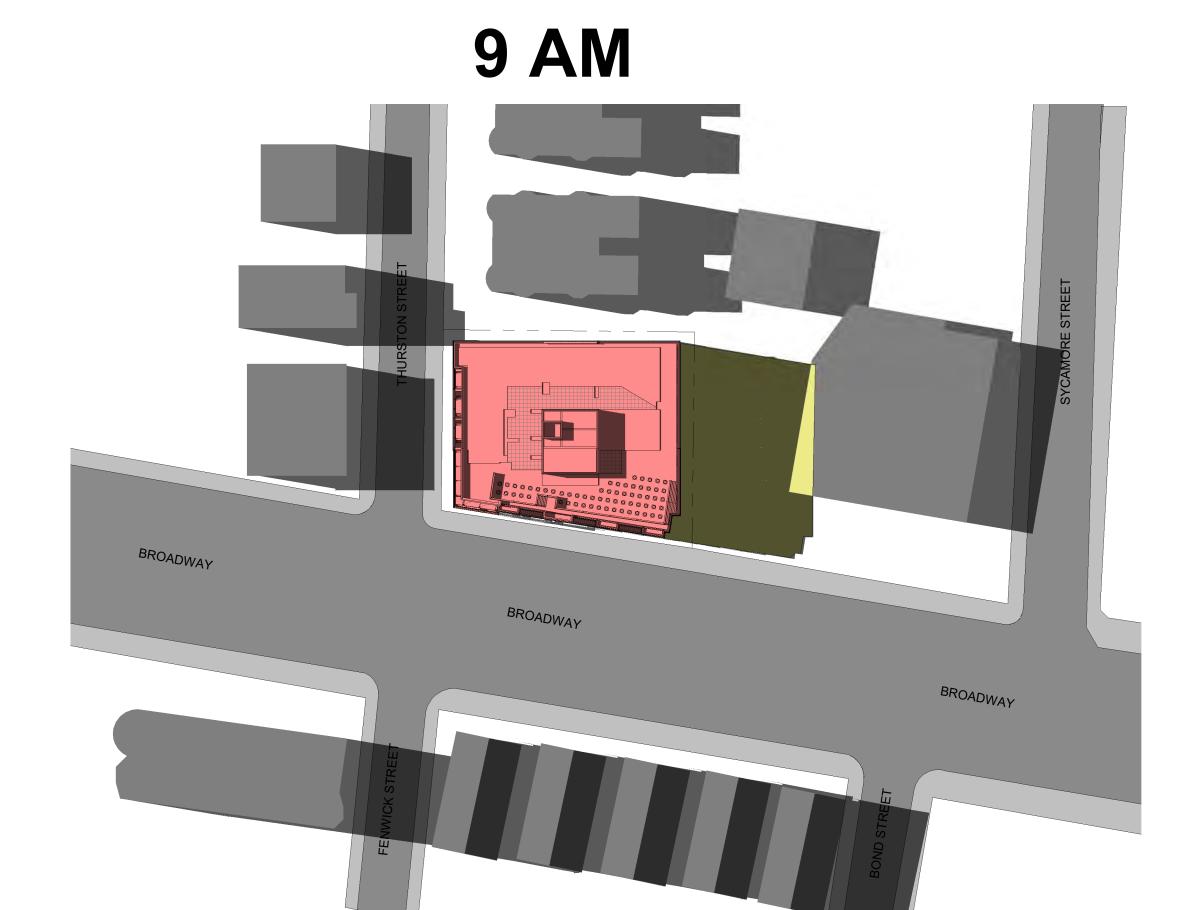
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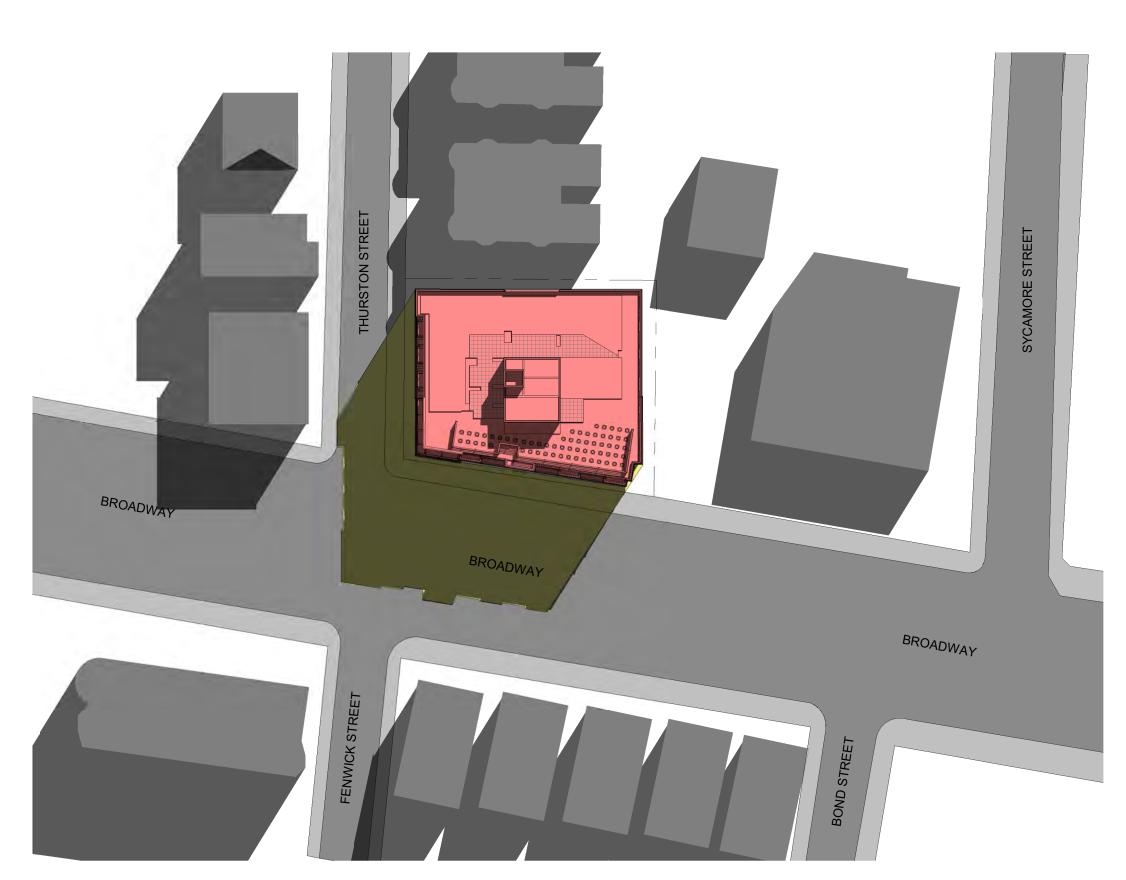
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Proposed Aerial


## **VERNAL EQUINOX (MARCH 21)**




3 PM



12 PM

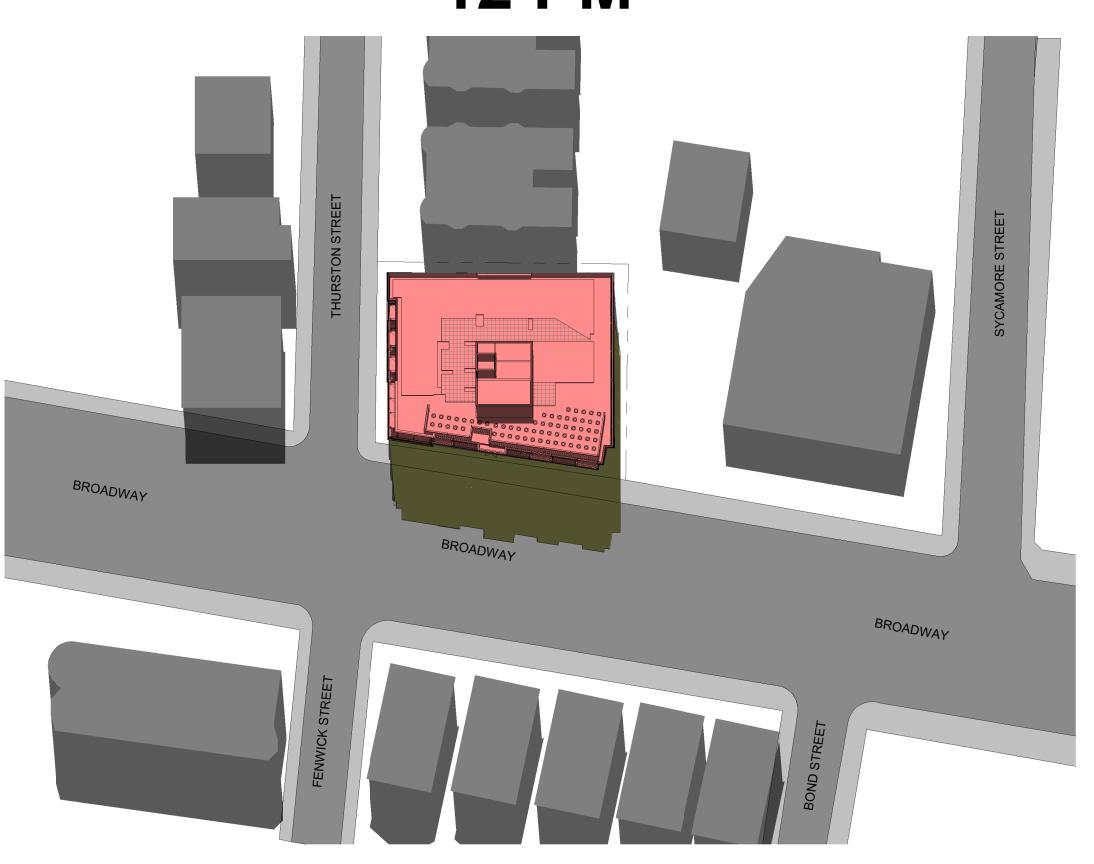

CUMULATIVE (HOURLY 9AM - 3PM)

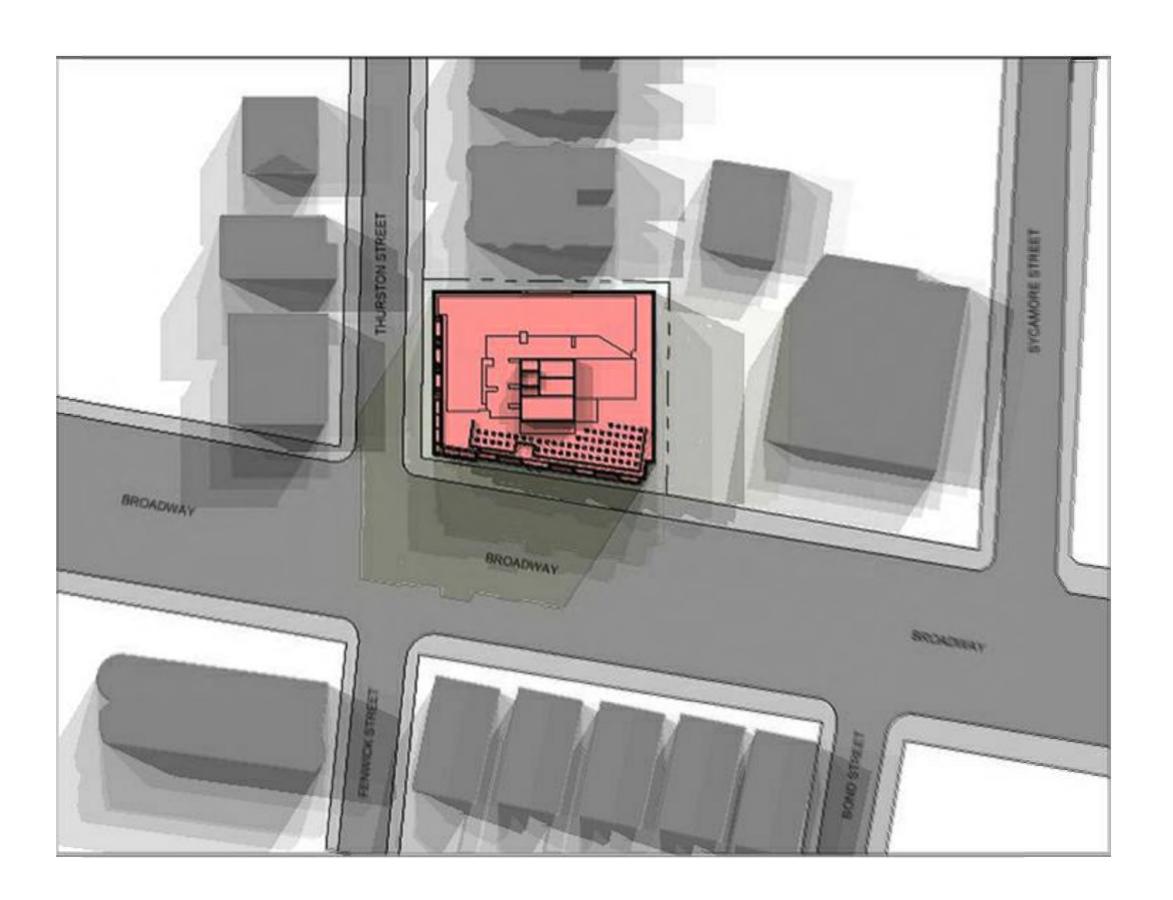

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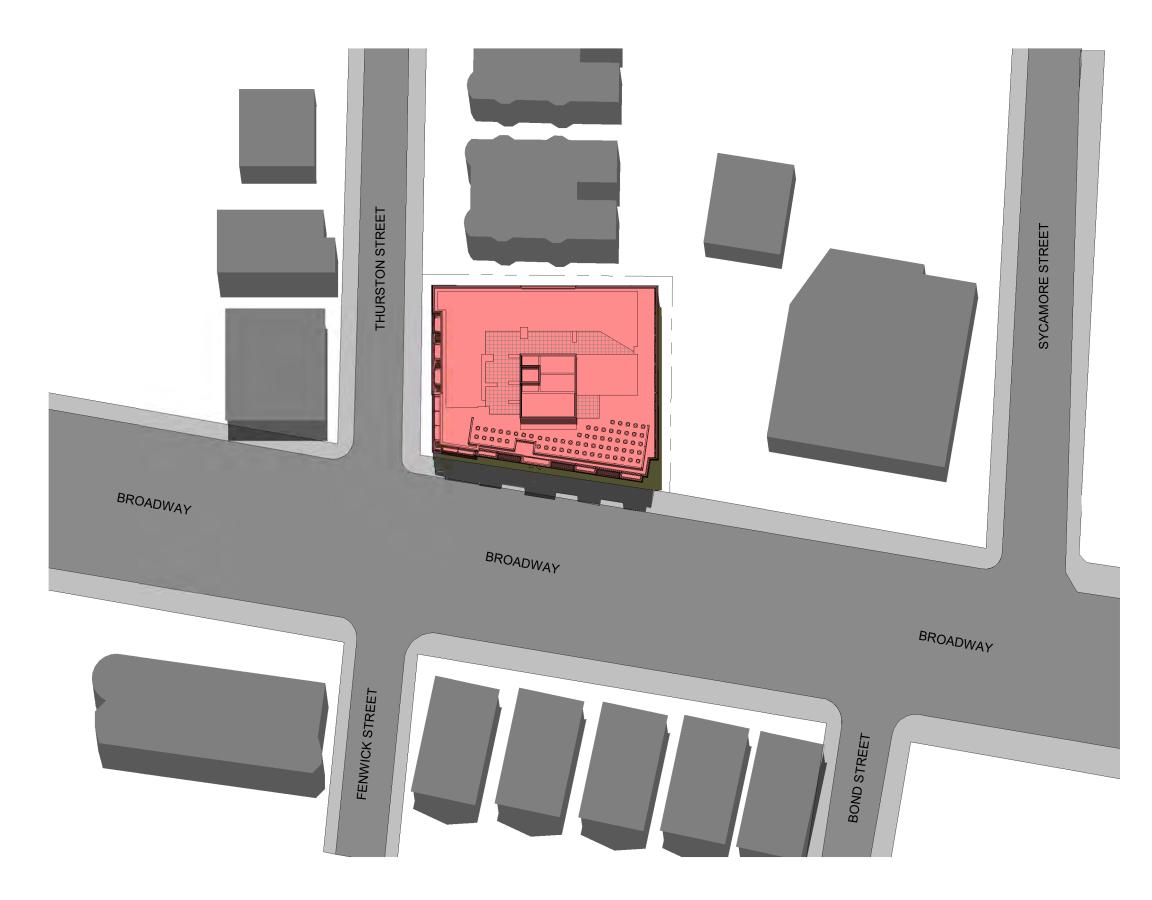
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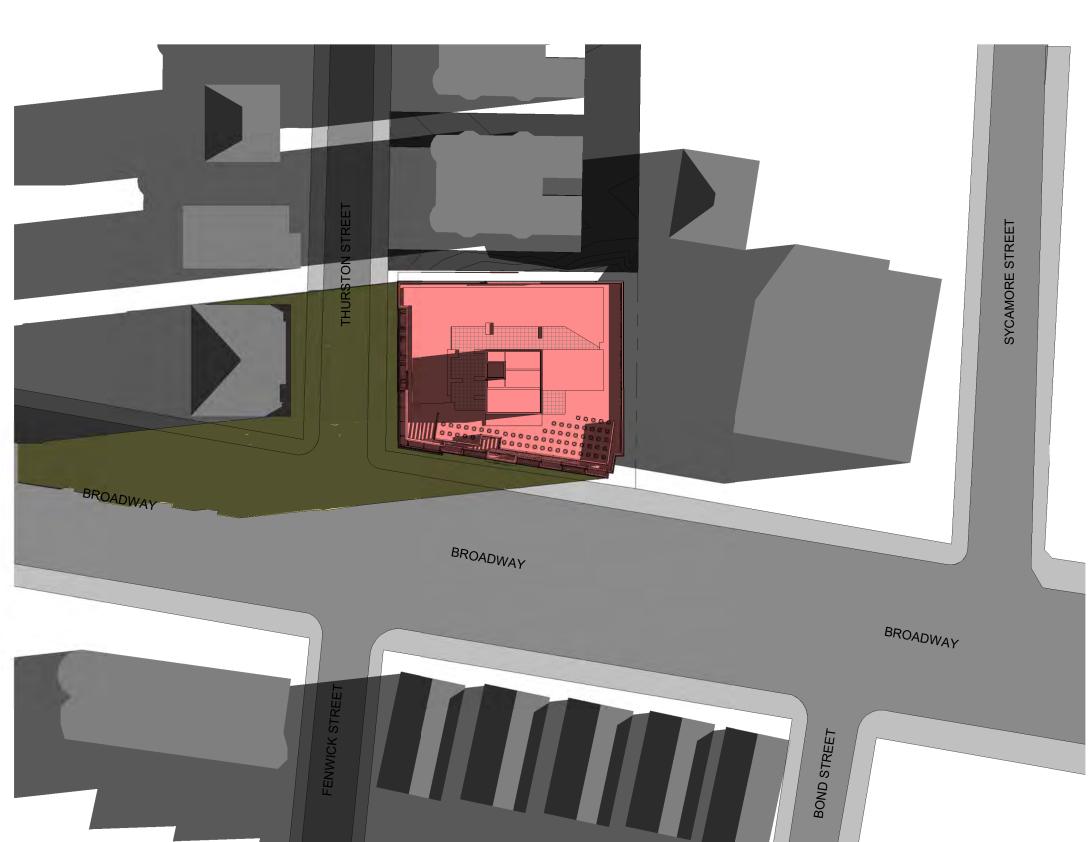
Shadow Study -Vernal Equinox

AV-8
366 Broadway Residences

## **SUMMER SOLSTICE (JUNE 21)**



6 PM




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9 AM



PROJECT NAME

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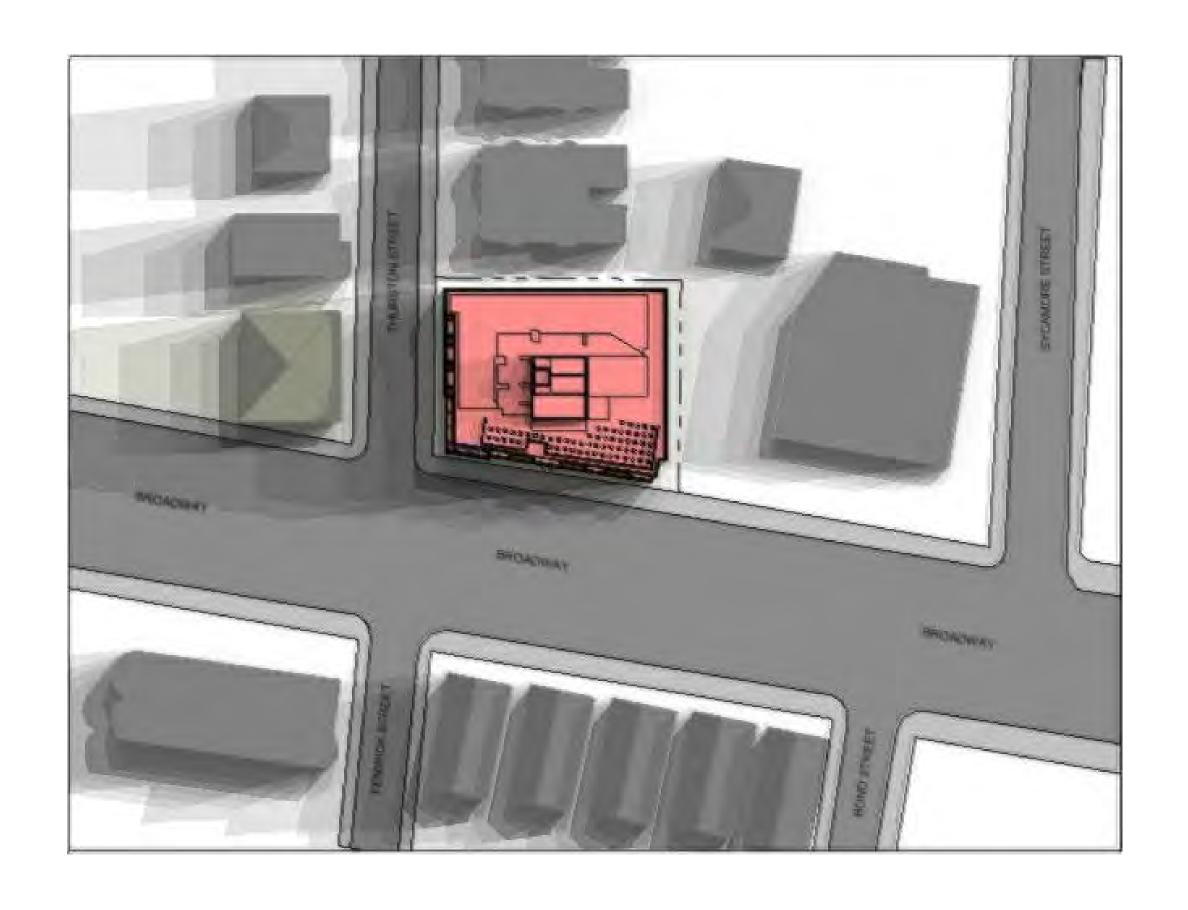
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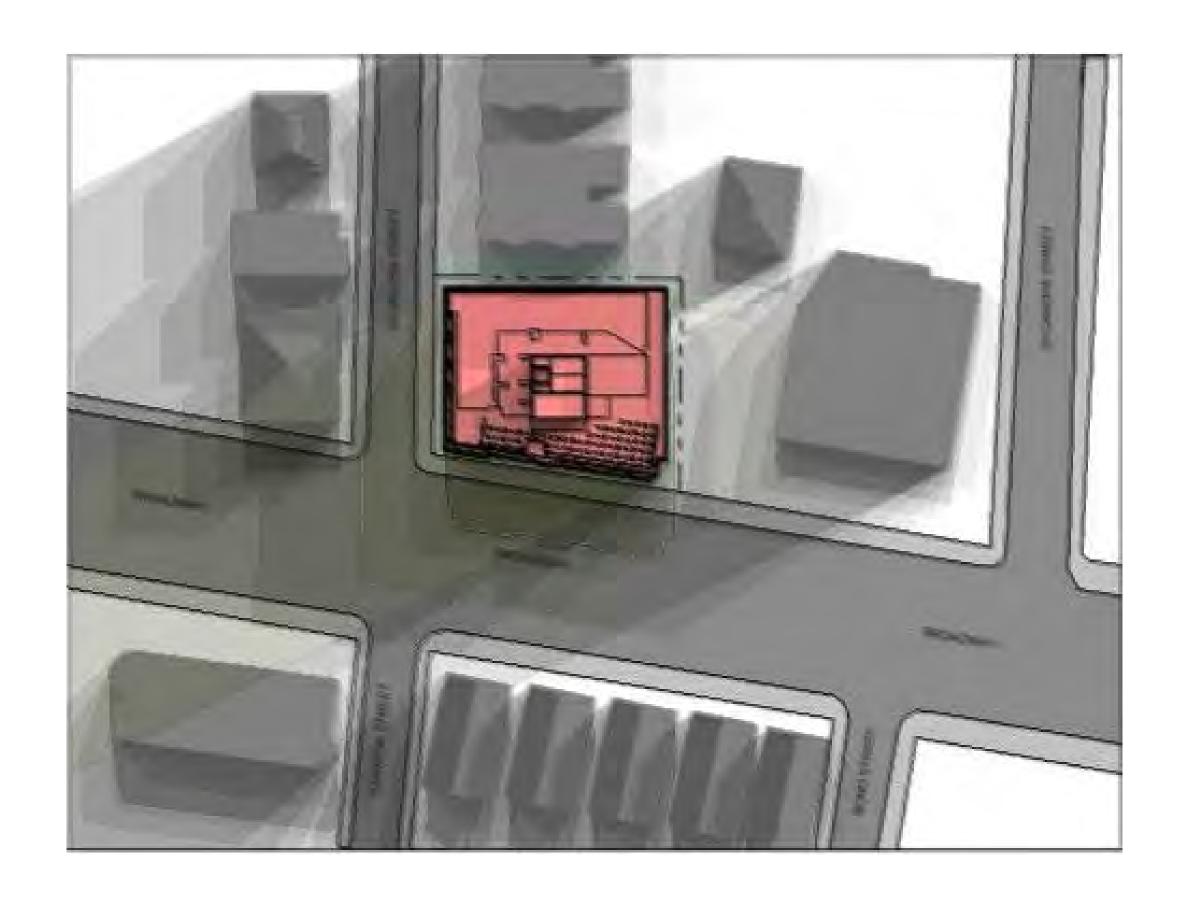
Shadow Study -Summer Solstice

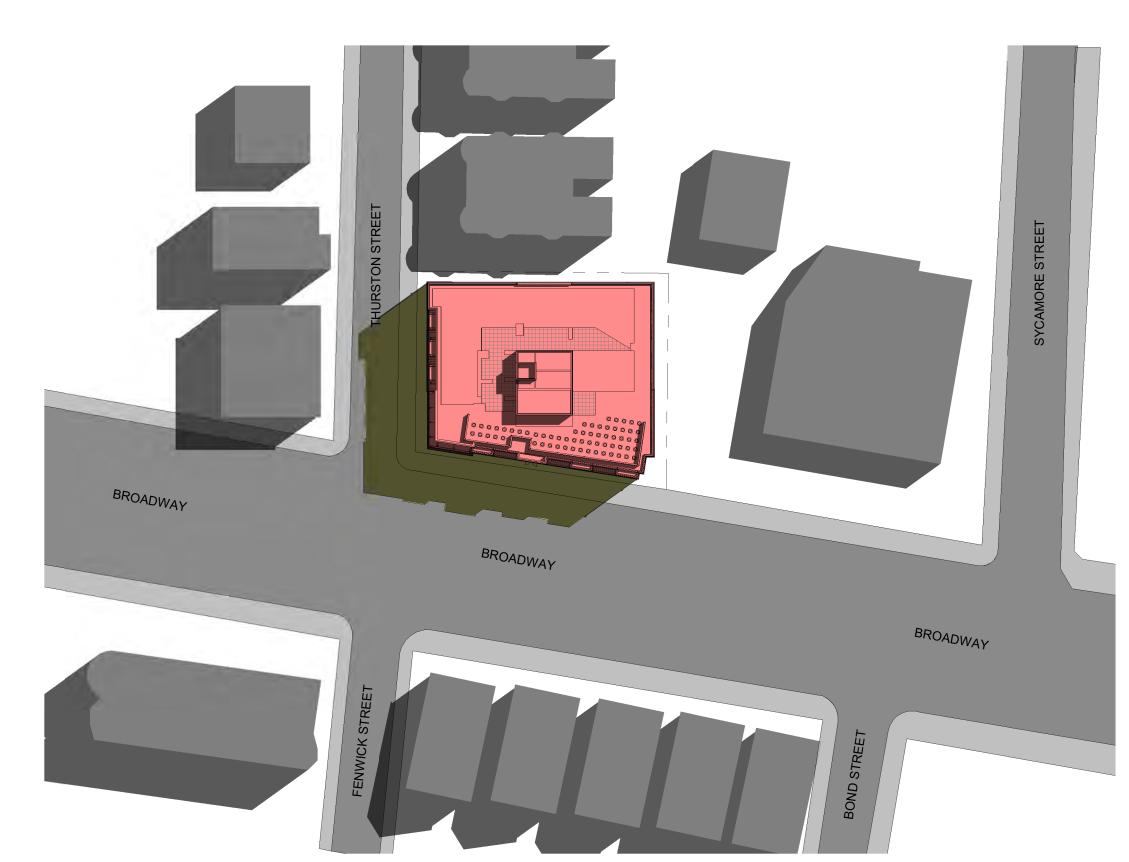AV-9 366 Broadway Residences CUMULATIVE (HOURLY 9 AM - 6PM)

## **AUTUMNAL EQUINOX (SEPTEMBER 21)**







PROJECT NAME


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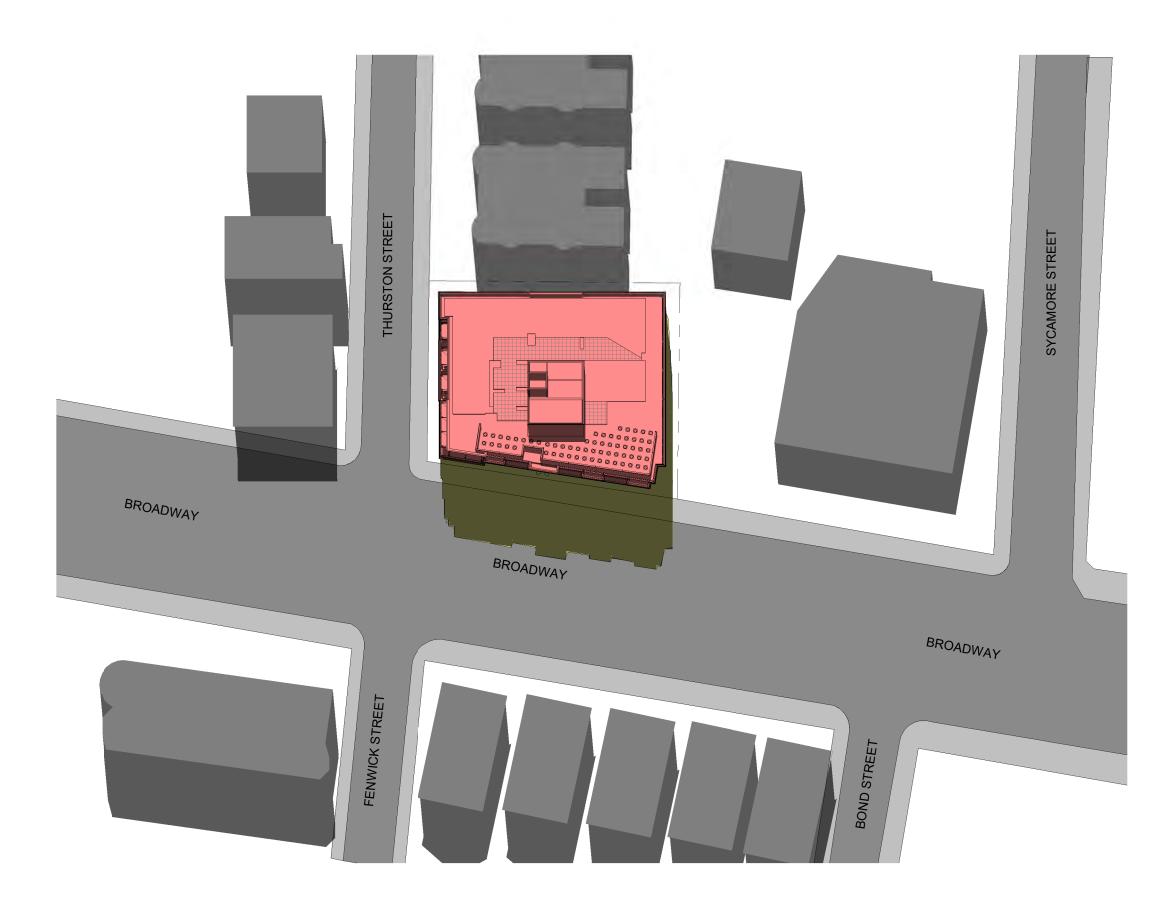
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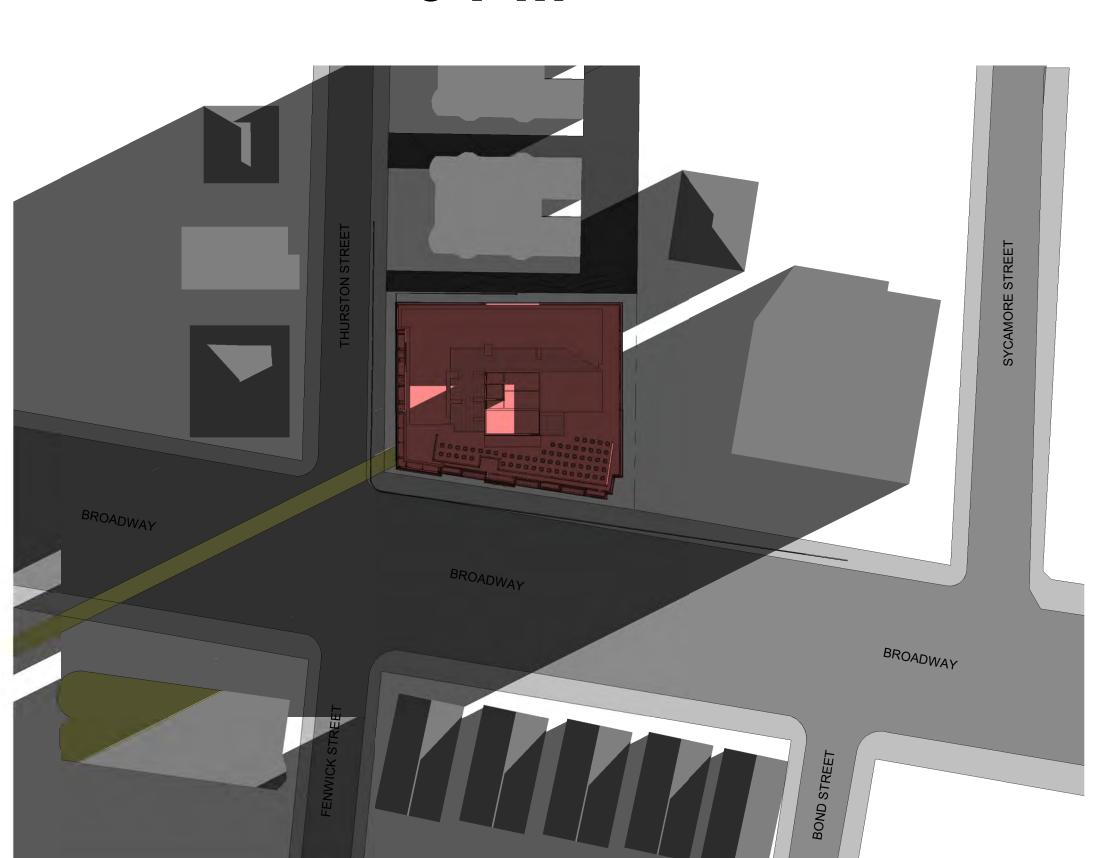
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Shadow Studies
-Summer Solstice /Autumnal Equinox


## **AUTUMNAL EQUINOX (SEPTEMBER 21)**




6 PM

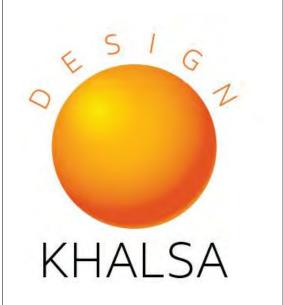

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PROJECT NAME

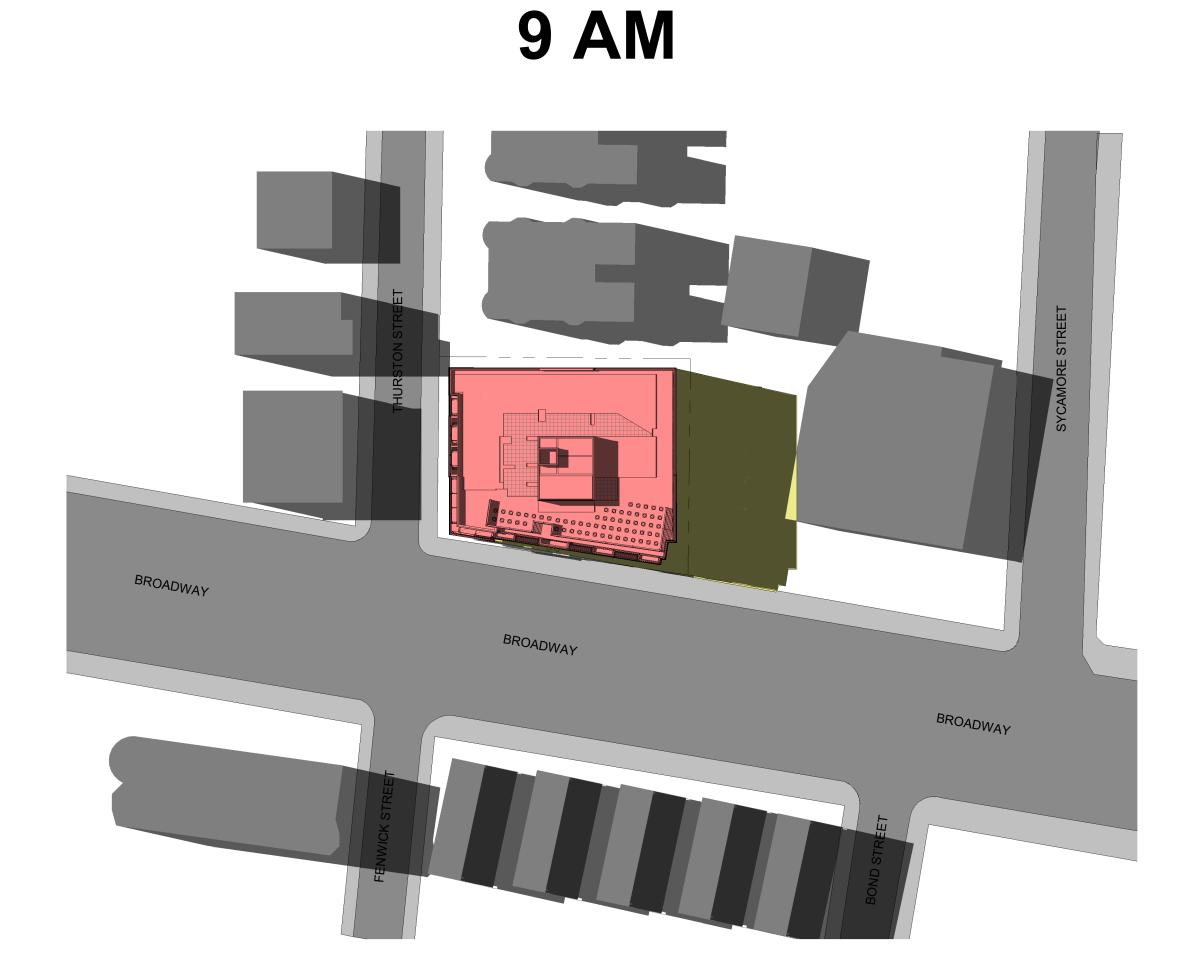366 Broadway Residences

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CLIENT
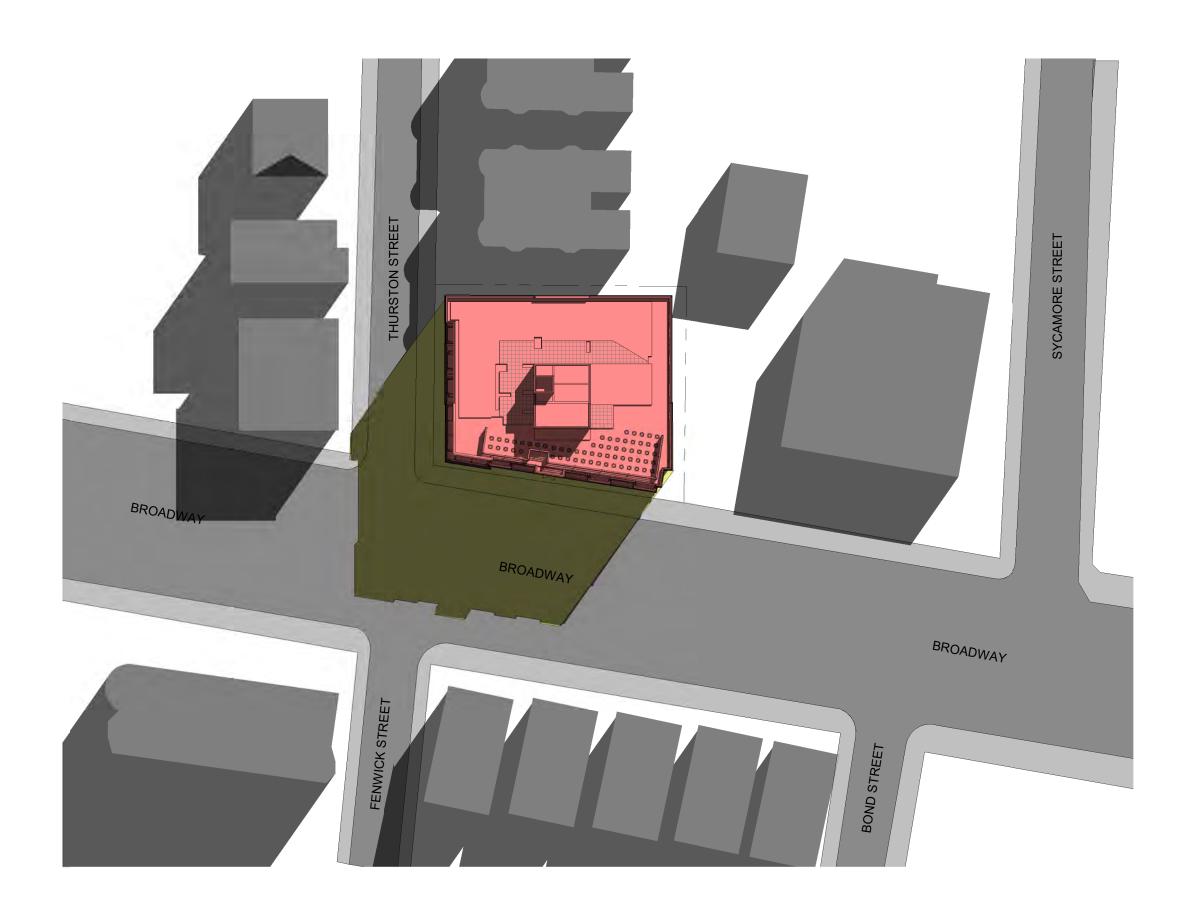
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ARCHITECT



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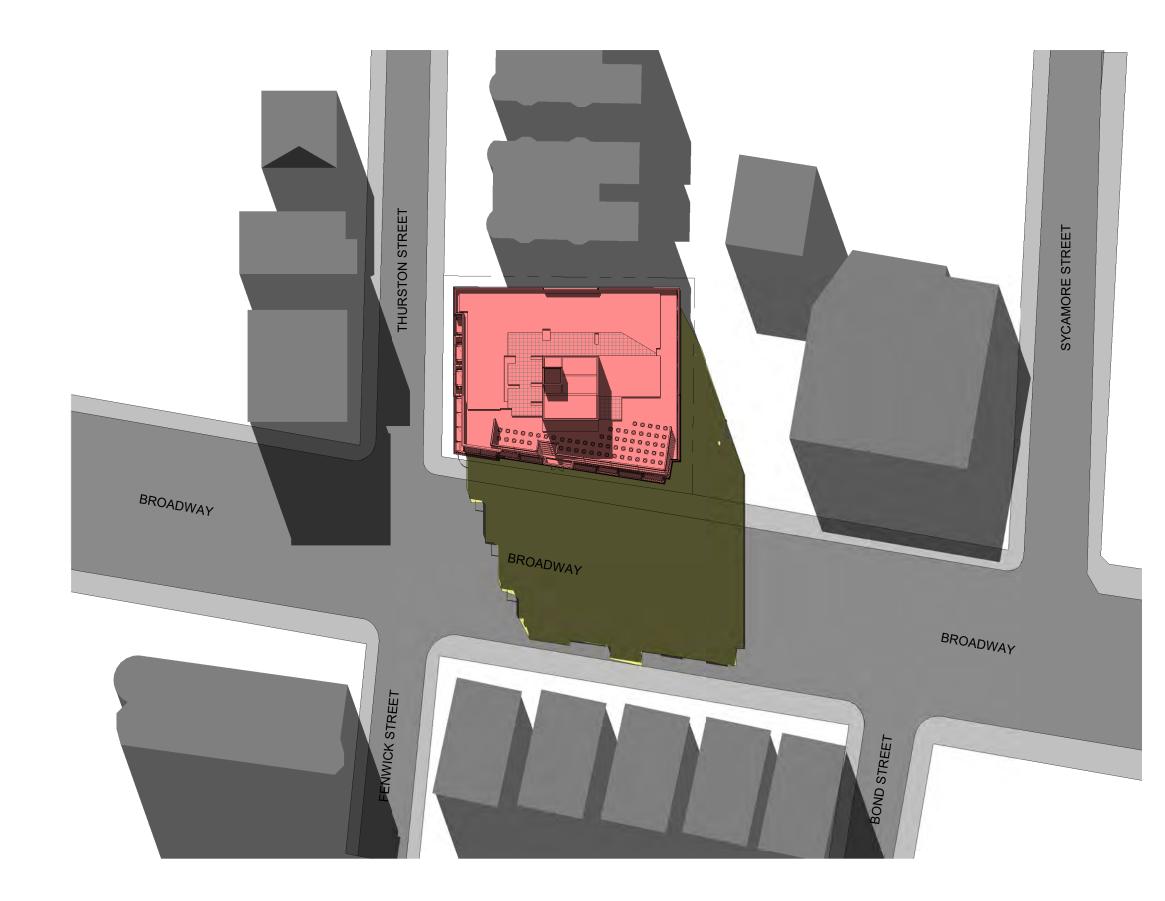
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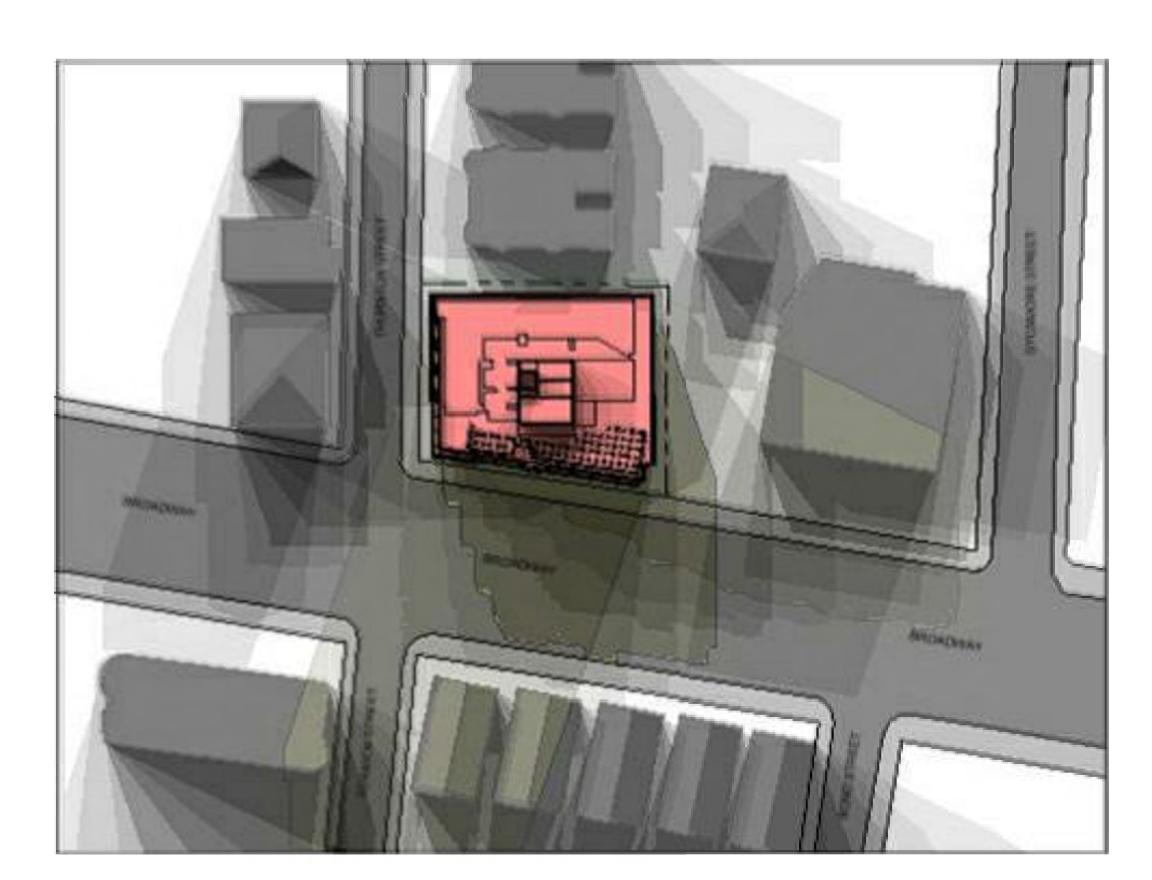
-Winter Solstice /Autumnal Equinox

**AV-11** 366 Broadway Residences


## WINTER SOLSTICE (DECEMBER 21)



## CUMULATIVE (HOURLY 9 AM - 3PM)




12 PM

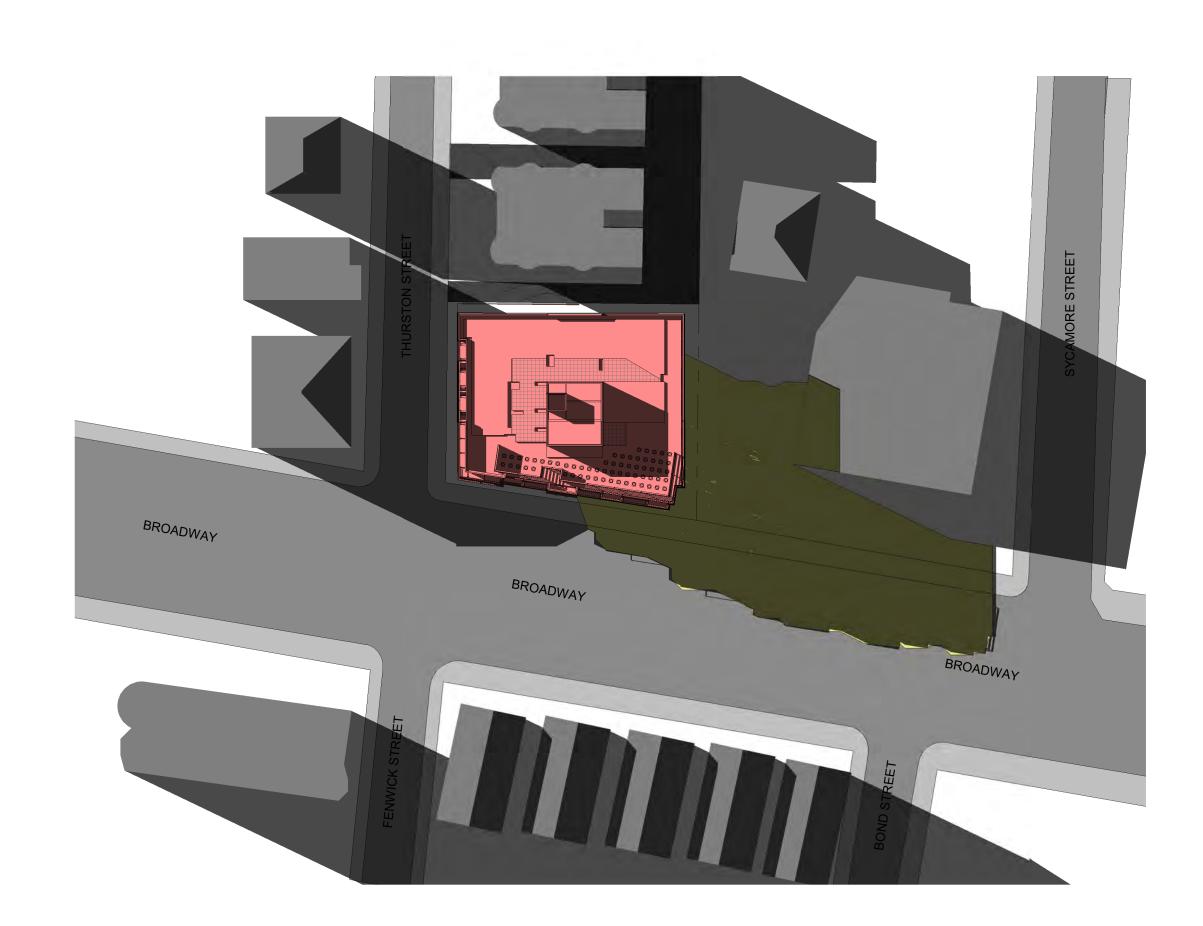

9 AM

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PROJECT NAME

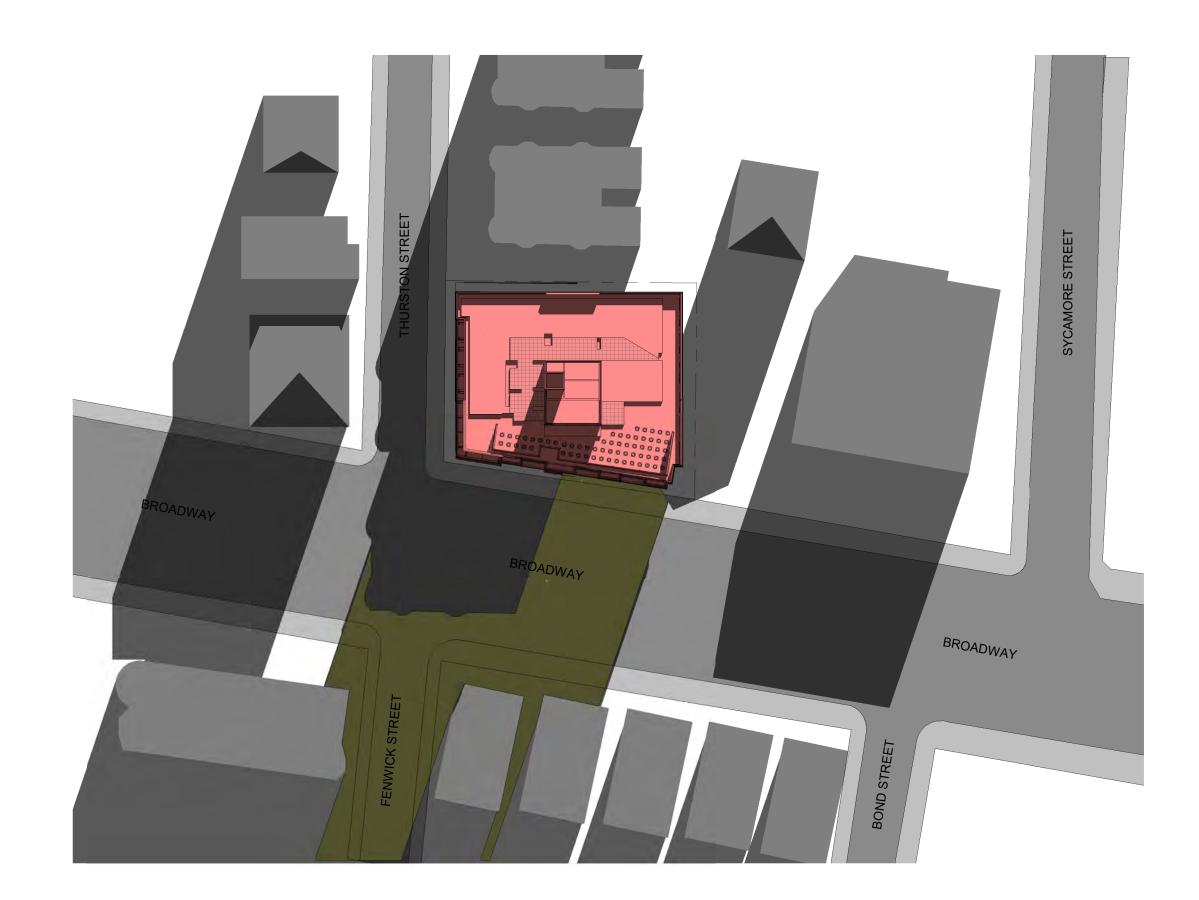366 Broadway Residences

PROJECT ADDRESS

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CLIENT

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ARCHITECT



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Winter Solstice Shadow Study

AV-12

366 Broadway Residences